GENOA CHARTER TOWNSHIP ZONING BOARD OF APPEALS AUGUST 20, 2024 6:30 P.M. AGENDA

| Pledge of Allegiance: |
|--|
| Introductions: |
| Conflict of Interest: |
| Approval of Agenda: |
| Call to the Public: (Please Note: The Board will not begin any new business after 10:00 p.m) |

OLD BUSINESS:

Call to Order:

1. 24-12... (APPLICANT REQUESTS TO BE POSTPONED TO 9-17-24 MEETING) A request by Michael Brown, 4655 Sweet Road, for a side yard setback variance and any other variance deemed necessary by the Zoning Board of Appeals, to allow solar panels to remain.

NEW BUSINESS:

- 2. 24-24...A request by Earl and Silvana Long, 1342 Elmhurst Dr., for a waterfront variance and any other variances deemed necessary by the Zoning Board of Appeals, to add a roof to an existing patio.
- 3. 24-25...A request by Gerard Delyon, 7022 Lindsey Dr., for a side yard setback variance and any other variances deemed necessary by the Zoning Board of Appeals, to construct a detached accessory building.

Administrative Business:

- 1. Approval of minutes for the July 23, 2024 Zoning Board of Appeals meeting.
- 2. Correspondence
- 3. Member Discussion
- 4. Adjournment

*Citizen's Comments- In addition to providing the public with an opportunity to address the Township Board at the beginning of the meeting, opportunity to comment on individual agenda items may be offered by the Chairman as they are presented. Anyone speaking on an agenda item will be limited to 2 minutes.



meeting.

GENOA CHARTER TOWNSHIP VARIANCE APPLICATION

2911 DORR ROAD | BRIGHTON, MICHIGAN 48116 (810) 227-5225 | FAX (810) 227-3420

| | for Sign Variance \$395.00 for Commercial/Industrial |
|---|--|
| Applicant/Owner: Earl and Silvana Long | Email: elong@comcast.net |
| Property Address: 1342 Elmhurst Drive | Phone: (248) 961-1601 |
| Present Zoning:_ LRR | Tax Code: 4711-10-202-038 |
| ARTICLE 23 of the Genoa Township Zoning Ordinal Zoning Board of Appeals. | nce describes the Variance procedure and the duties of the |
| change the Zoning Ordinance or grant relief when i | ally by the ZBA. The ZBA is a board of limited power; it cannot t is possible to comply with the Zoning Ordinance. It may roperty with strict application of the zoning ordinance to the pardship. |
| much of the necessary information is gathered thro | rmation necessary to support the relief requested. While ough the completed application, other information may be g the ZBA meeting. ZBA members, township officials and cation to property owners. |
| Failure to meet the submittal requirements and pr | |
| improvements may result in postponement or den | ial of this petition. |
| Please explain the proposed variance below: | |
| Please explain the proposed variance below: | tions: We are requesting a variance to put a roof |
| Please explain the proposed variance below: 1. Variance requested/intended property modifications. | tions: We are requesting a variance to put a roof e can sit out and enjoy the view, rain or shine, just |

available to review at https://www.genoa.org/government/boards/zoningboard five days prior to the

The following is per Article 23.05.03 of the Genoa Township Ordinance:

<u>Criteria Applicable to Dimensional Variances.</u> No variance in the provisions or requirements of the Ordinance shall be authorized by the Board of Appeals unless it is found from the evidence that <u>all</u> of the following conditions exist:

Under each please indicate how the proposed project meets each criteria.

<u>Practical Difficulty/Substantial Justice.</u> Compliance with the strict letter of the restrictions governing area, setbacks, frontage, height, bulk, density, or other dimensional provisions would unreasonably prevent the use of the property. Granting of a requested variance or appeal would do substantial justice to the applicant as well as to other property owners in the district and is necessary for the preservation and enjoyment of a substantial property right similar to that possessed by other properties in the same zoning district and vicinity of the subject parcel.

Strict compliance would preclude the affected area of the property from being used or enjoyed similarly to neighboring and surrounding properties. Both neighboring properties and a multitude of surrounding properties enjoy similar or greater awning awning coverage, so granting the variance would render substantial justice to the property owner without impeding others.

<u>Extraordinary Circumstances</u>. There are exceptional or extraordinary circumstances or conditions applicable to the property or the intended use which are different than other properties in the same zoning district or the variance would make the property consistent with the majority of other properties in the vicinity. The need for the variance was not self-created by the applicant.

The waterfront encroaches into the property further than the neighbors due to the existing location of the seawall and concrete slab, both of which existed prior to the property owners' ownership and have been there for 30-40 years. The seawall cannot be removed because it is connected to the neighbors' seawalls.

<u>Public Safety and Welfare</u>. The granting of the variance will not impair an adequate supply of light and air to adjacent property or unreasonably increase the congestion in public streets, or increase the danger of fire or endanger the public safety, comfort, morals or welfare of the inhabitants of the Township of Genoa.

Granting this variance will have no substantive impact on the supply of light or air to the adjacent properties. It will not cause increased traffic congestion, nor will it increase any fire risk. It will not endanger public safety, comfort, morals, or welfare.

<u>Impact on Surrounding Neighborhood.</u> The variance will not interfere with or discourage the appropriate development, continued use, or value of adjacent properties and the surrounding neighborhood.

Granting the variance will have no negative impact on the development, continued use, or value of any properties in the surrounding area. We have spoken with our neighbors, all of whom are in support of this variance being granted.

Attendance by the applicant is required at the Zoning Board of Appeals meeting.

Any Variance not acted upon within 12 months from the date of approval is invalid and must receive a renewal from the Zoning Board of Appeals (ZBA).

After the decision is made regarding your Variance approval a land use permit will be required with additional site plans and construction plans.

Date: July 17, 2024 Signature: Earl Long



2911 Dorr Road Brighton, MI 48116 810.227.5225 810.227.3420 fax genoa.org

MEMORANDUM

TO: Genoa Township Zoning Board of Appeals

FROM: Carrie Aulette, Zoning Official

DATE: June 11, 2018

RE: ZBA 24-24

STAFF REPORT

File Number: ZBA# 24-24

Site Address: 1342 Elmhurst Drive

Parcel Number: 4711-10-202-038

Parcel Size: .278 Acres

Applicant: Earl and Silvana Long, 1342 Elmhurst Drive, Howell

Property Owner: Same as Applicant

Information Submitted: Application, site plan, conceptual drawings

Request: Dimensional Variance

Project Description: Applicant is requesting a waterfront yard variance to construct a

roof over an existing concrete patio.

Zoning and Existing Use: LRR (Lakeshore Resort Residential) Single Family Dwelling

located on property.

Other:

Public hearing was published in the Livingston County Press and Argus on Sunday August 4, 2024 and 300 foot mailings were sent to any real property within 300 feet of the property in accordance with the Michigan Zoning Enabling Act.

Background

The following is a brief summary of the background information we have on file:

- Per assessing records the existing home on the parcel was constructed in 2018.
- The parcel is serviced by well and public sewer.
- See Assessing Record Card.

The proposed project is to add a roof structure to an existing patio. In order to construct the roof as proposed, the applicant is required to obtain a waterfront variance The Township Assessor has verified that the applicant does own to the water's edge. The applicant is not proposing to encroach any closer into the side yard setback than the current home. The Applicant should clarify if this structure is going to be enclosed due to a note on the construction plan about future privacy screening.

SUPERVISOR

Bill Rogers

CLERK

Paulette A. Skolarus

TREASURER

Robin L. Hunt

TRUSTEES

Jean W. Ledford H. James Mortensen Terry Croft Diana Lowe

MANAGER

Kelly VanMarter

Variance Requests

The following is the section of the Zoning Ordinance that the variance is being requested from:

Table 3.04.01 (LRR District):

Required Waterfront Yard Setback: 97.25'
Proposed Waterfront Yard Setback: 87.70'
Proposed Variance Amount: 9.55'

<u>Summary of Findings of Fact-</u> After reviewing the application and materials provided, I offer the possible findings of fact for your consideration:

Please note that in order for a variance to be approved it has to meet all of the standards in 23.05.03.

- (a) Practical Difficulty/Substantial Justice Strict compliance with the waterfront setback would prevent the applicant from constructing the roof structure over an existing concrete patio as proposed. The applicant is proposing to not encroach any further into side yard setbacks as the current house location. There are other homes in the vicinity with reduced waterfront yard setbacks that would support substantial justice.
- (b) Extraordinary Circumstances The exceptional or extraordinary condition of the property is that the waterfront encroaches into the property more so than some of the other homes in the area. This is due to an existing seawall and concrete slab which existed prior to this home being built. It is connected to neighboring seawalls and cannot be removed. Granting of the variance would make it consistent with many homes in the vicinity. The need for the variance is not self-created.
- (c) Public Safety and Welfare The granting of the variance will not impair an adequate supply of light and air to adjacent property or unreasonably increase the congestion in public streets, or increase the danger of fire or endanger the public safety, comfort, morals or welfare of the inhabitants of the Township of Genoa.
- (d) Impact on Surrounding Neighborhood The proposed variance would have little or no impact on the appropriate development, continued use, or value of adjacent properties and the surrounding neighborhood.

Recommended Conditions

If the Zoning Board of Appeals grants the variance requests staff recommends the following conditions be placed on the approval.

- 1. Structure must be guttered with downspouts.
- 2. If at anytime applicants intend to enclose this structure, permits will be required.



Genoa Township

2911 Dorr Road, Brighton, Michigan 48116 Phone: 810.227.5225 Fax: 810.227.3420 www.genoa.org

Planning & Zoning

P18-155

Issued: 08/08/2018 Expires: 08/08/2019

Residential Land Use

Residential New Construction

| LOCATION | OWNER | APPLICANT |
|---|--|--|
| 1342 ELMHURST DR 4711-10-202-038 Zoning: LRR | LONG FAMILY TRUST 1907 CORDERO CT LADY LAKE FL 32159 | LONG FAMILY TRUST 1907 CORDERO CT LADY LAKE FL 32159 |
| | Phone: E-mail: | Phone: E-mail: |

Work Description: Construct a 4025 Sq.ft. single farmily home with attached garage.

PROJECT INFORMATION:

Front Setback: 36.3 Side Setback: 12 Water/Wetland:
Least Side Setback: 5.1 Rear Setback: 102.5 Distance from Principal Structure:

Construction Value: \$600,000.00 Height: Total Square Feet: 4,025

ZBA Approval: n/a

Comments/ Conditions:

| Permit Item | Permit Fee | Fee Basis | Item Total |
|---------------------------------------|------------|-----------|------------|
| Residential New Construction/Addition | Permit Fee | 1.00 | 75.00 |

Fee Total: \$75.00 Amount Paid: \$75.00

Balance Due: \$0.00

Issuance of this permit confirms the applicants certification that all information and data attached to and made part of this permit are true and accurate and to the best of the applicants knowledge and belief. The applicant has certified that the proposed work has been authorized by the owner of record and that the applicant has been authorized by the owner to obtain this permit as the authorized agent. The applicant has agreed to conform to all applicable laws, codes and ordinances of the State of Michigan, Livingston County and Genoa Township. The applicant acknowledges that private covenants and restrictions are potentially enforceable by private parties. This permit authorizes on-site inspections by an official representative of Genoa Charter Township. This permit is valid for a period of 12 months from the date of issue and the applicant agrees that any modifications must be approved by Genoa Township.

LEGAL DESCRIPTION:

Lot 13 and a portion of Outlot D, Plat of Elmhurst Subdivision, a part of the Southeast 1/4 of the Northeast 1/4, Section 10, Town 2 North, Range 5 East, Genoa Township, Livingston County, Michigan, recorded as Document No. 19973 in Liber 2, Page 40, Livingston County Records, being more particularly described as Beginning at the Northwest Corner of said Lot 13; thence S 65*30'00" E along the Northerly Line of said Lot 13 a distance of 50.00 feet to the Northeast Corner of said Lot 13; thence S 29°26'59" W along the Easterly Line of said Lot 13 a distance of 153.20 feet to the Southeast Corner of said Lot; thence continuing S 29°26'59" W a distance of 54.48 feet to a found capped iron, said point being Point A; thence continuing S 29°26'59" W approximately 2 feet to the water's edge, being the northerly shore of Lake Chemung; thence Northwesterly along said shoreline of Lake Chemung approximately 101 feet to a point, said point being S 3519'19" W, approximately 101 feet to a point, said point being 5.35.19.19 w, approximately 17 feet from a found iron pipe, said pipe being Point "B", said Point "B" being N 58'23'50" E a distance of 97.00 feet from said Point "A"; thence continuing from said Point "B" N 35'19'19" E a distance of 42.86 feet to a found iron pipe, said pipe being the Southwest Corner of said Lot 13; thence N 44'40'58" E along the West Line of said Lot a distance of 162.80 feet (recorded as 162.50 feet) to the Point of Beginning. Containing 0.37 Acres (more or less) and subject to all easement and encumbrances of record.

NOTES:


1. NO TITLEWORK WAS SUPPLIED BY CLIENT THEREFORE ALL EASEMENTS OF RECORD MAY NOT BE SHOWN.

HELD BEARING BASIS AS PER PLAT OF RECORD.

3. THE 100 YEAR FLOOD ZONE = 961.1' (NAVD 1988 DATUM)

4. ALL ELEVATIONS ARE SHOWN IN NAVD 1988 DATUM.

SITE PLAN

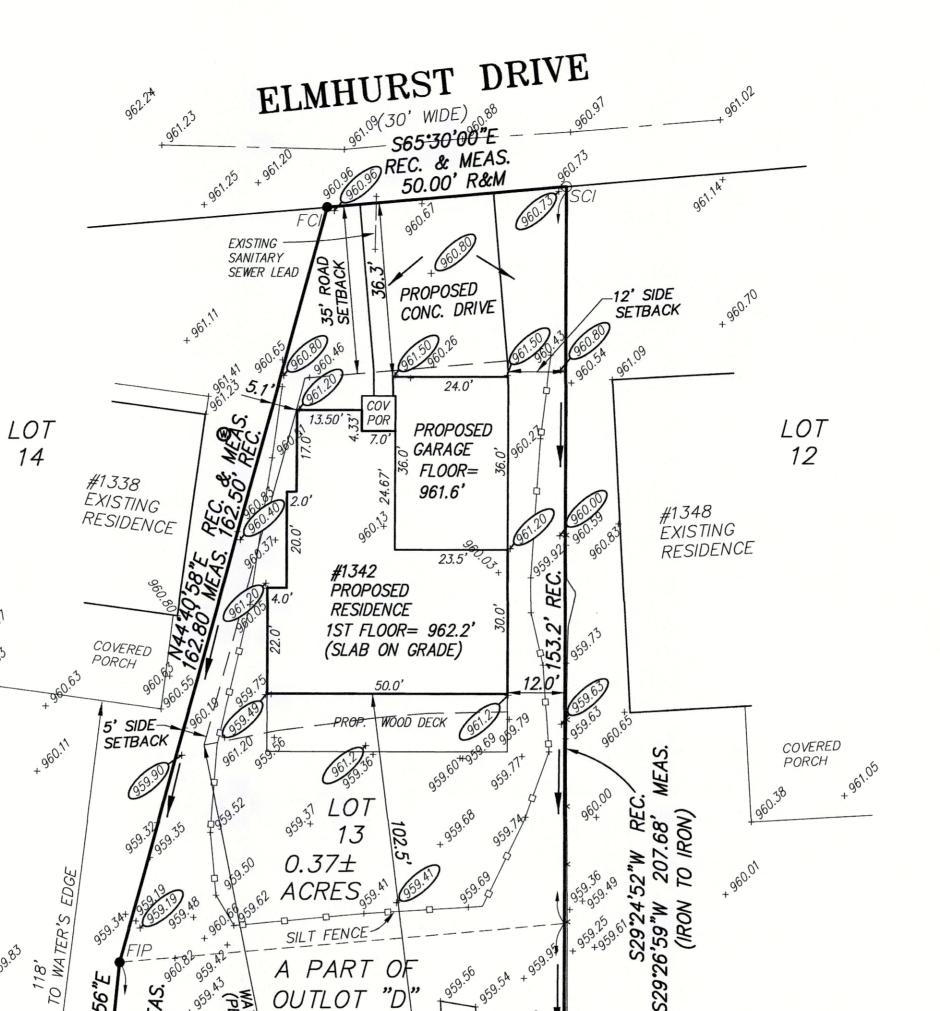

POINT

SILT FENCE

OUTLOT

.959N58°23'50 W

WATER'S-FDGE

3575


POINT

A PART OF

LAKE CHEMUNG

TOP OF WATER

ELEV.= 957.62

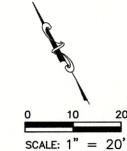

BENCHMARK:

SITE BENCHMARK MAG NAIL IN NORTH SIDE OF ELMHURST DRIVE ELEV. = 962.24'(NAVD 1988 DATUM)

ZONING CHART ZONED: LRR (LAKESHORE RESORT RESIDENTIAL)

SETBACKS

ROAD = 35' MIN. SIDE = 12' MIN. (ONE SIDE) SIDE = 5' MIN. (OTHER SIDE) WATER = 97.5' (PER TOWNSHIP)

Minimum 2 sides must be no less than 15' total

GENOA TOWNSHIP

Amy Ruthig

8-8-18

PERMIT APPROVED

See Conditions



ALPINE 11590 HIGHLAND ROAD, SUITE #100 HARTLAND, MI 48353 PHONE: 810-207-8050, FAX: 419-735-0171 Land Surveying, Inc.

JULY 5, 2018 FIELD: DATE: JOB NO: 17-3289 DRAWN: DS CHECKED: KG SHEET: 1 OF 1 REVISION: REV HOUSE & TITLEBLOCK JULY 20, 2018

LEGEND

- EXISTING WELL - IRON SET - IRON FOUND - EXISTING ELEVATION - PROPOSED ELEVATION RECORDED - FOUND CAPPED IRON - PROPOSED DRAINAGE - FOUND IRON PIPE - SET CAPPED IRON - 100 YEAR FLOOD PLAIN LINE - POINT OF BEGINNING P.O.B. 961.1' (NAVD 88 DATUM)

UNDERGROUND UTILITY LOCATIONS AS SHOW ON THE PLAN, WERE OBTAINED FROM UTILITY OWNERS AND WERE NOT FIELD LOCATED.

BEFORE YOU DIG

A MINIMUM OF 3 WORKING DAYS PRIOR TO BEGINN
CALL MISS DIG

A MINIMUM OF 3 WORKING DAYS PRIOR TO BEGINN
CONSTRUCTION, THE CONTRACTOR SHALL NOTIFY
STANED BEFORE ANY WORK MAY BEGIN. CALL MISS DIG 1-800-482-7171 THE CONTRACTOR SHALL BE RESPONSIBLE FOR THE PROTECTION AND OR RELOCATION OF ALL UTILITIES THAT MAY INTERFERE WITH CONSTRUCTION.



Prepared For: EARL LONG

LEGAL DESCRIPTION:

Lot 13 and a portion of Outlot D, Plat of Elmhurst Subdivision, a part of the Southeast 1/4 of the Northeast 1/4, Section 10, Town 2 North, Range 5 East, Genoa Township, Livingston County, Michigan, recorded as Document No. 19973 in Liber 2, Page 40, Livingston County Records, being more particularly described as Beginning at the Northwest Corner of said Lot 13; thence S 65°30'00" E along the Northerly Line of said Lot 13 a distance of 50.00 feet to the Northeast Corner of said Lot 13; thence S 29°26'59" W along the Easterly Line of said Lot 13 a distance of 153.20 feet to the Southeast Corner of said Lot; thence continuing S 29°26'59" W a distance of 54.48 feet to a found capped iron, said point being Point A; thence continuing S 29°26'59" W approximately 2 feet to the water's edge, being the northerly shore of Lake Chemung; thence Northwesterly along said shoreline of Lake Chemung approximately 101 feet to a point, said point being S 35°19'19" W, approximately 17 feet from a found iron pipe, said pipe being Point "B", said Point "B" being N 58°23'50" E a distance of 97.00 feet from said Point "A"; thence continuing from said Point "B" N 3519'19" E a distance of 42.86 feet to a found iron pipe, said pipe being the Southwest Corner of said Lot 13; thence N 44°40'58" E along the West Line of said Lot a distance of 162.80 feet (recorded as 162.50 feet) to the Point of Beginning. Containing 0.37 Acres (more or less) and subject to all easement and encumbrances of record.

NOTES:


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4. ALL ELEVATIONS ARE SHOWN IN NAVD 1988 DATUM.

SITE PLAN



ELEV.= 957.62

7-16-2024 NOTE:

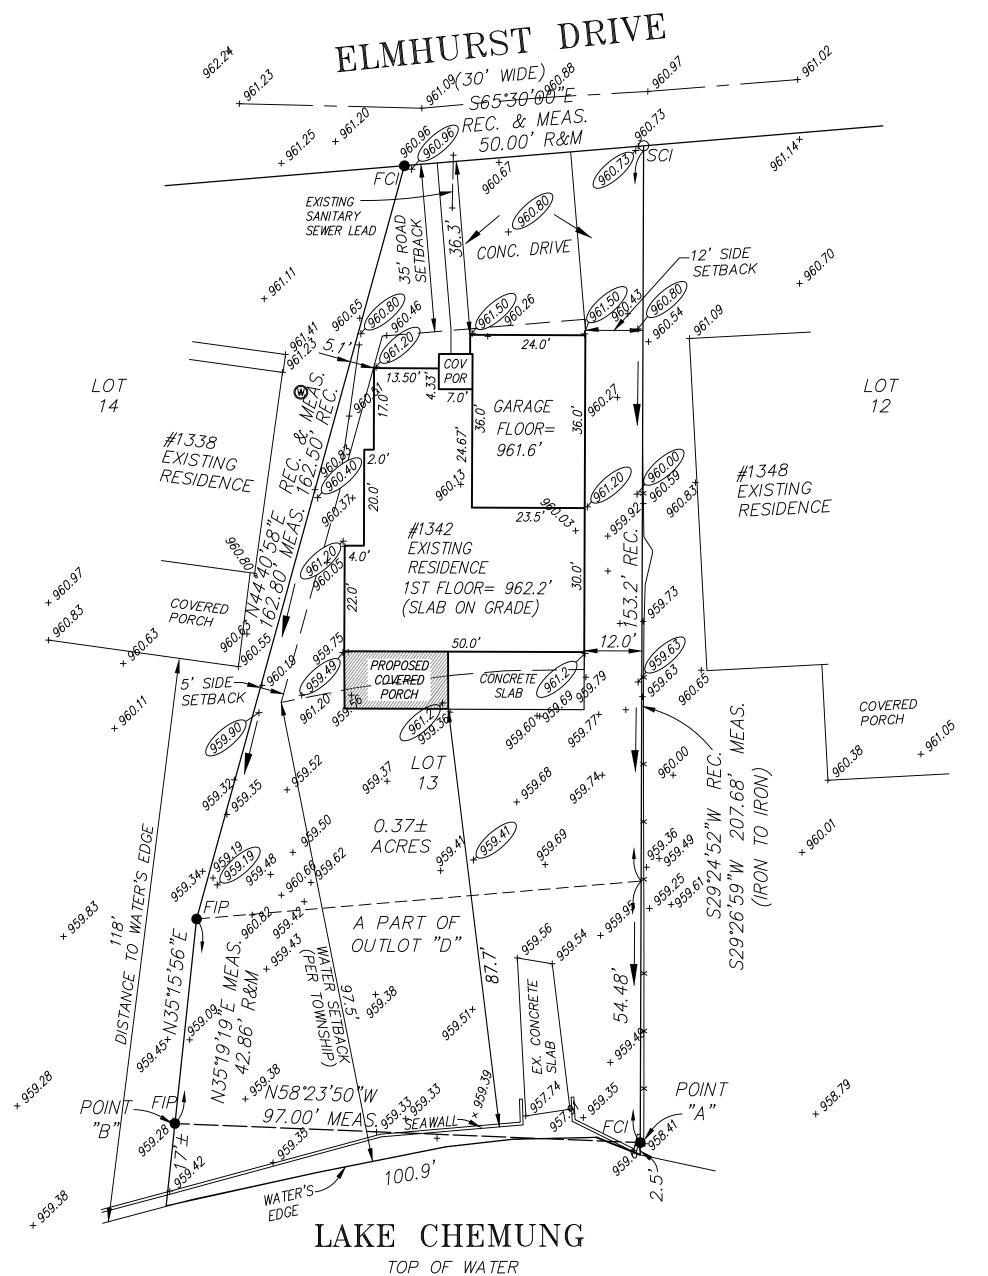
TO EXISTING SEAWALL.

OBSERVED HIGH WATER AT THIS

TIME. WATER IS CURRENTLY AT

SEAWALL. SEE DISTANCE FROM

PROPOSED COVERED PORCH AREA

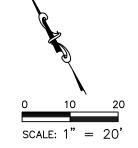

BENCHMARK:

SITE BENCHMARK MAG NAIL IN NORTH SIDE OF ELMHURST DRIVE ELEV. = 962.24'(NAVD 1988 DATUM)

ZONING CHART ZONED: LRR (LAKESHORE RESORT RESIDENTIAL)

SETBACKS

ROAD = 35' MIN.SIDE = 12' MIN. (ONE SIDE)
SIDE = 5' MIN. (OTHER SIDE)
WATER = 97.5' (PER TOWNSHIP)

Minimum 2 sides must be no

less than 15' total

KAROL GROVE **PROFESSIONAL** SURVEYOR

KAROL L. GROVE LICENSED PROFESSIONAL SURVEYOR #39075

376 BEECH FARM CIRCLE #1293 PINE HIGHLAND, MI 48357 PHONE: 810-207-8050 Land Surveying, Inc.


FIELD: JULY 5, 2018 KG DATE: DRAWN: DS JOB NO: 17-3289 CHECKED: KG SHEET: 1 OF 1 REVISION: REV HOUSE & TITLEBLOCK JULY 20, 2018 ADDED PROPOSED PORCH JULY 16, 2024




 EXISTING WELL - IRON SET - IRON FOUND - EXISTING ELEVATION MEAS. - PROPOSED ELEVATION REC. RECORDED FCI - FOUND CAPPED IRON - PROPOSED DRAINAGE FIP - FOUND IRON PIPE - - SILT FENCE SCI - SET CAPPED IRON - POINT OF BEGINNING - 100 YEAR FLOOD PLAIN LINE

961.1' (NAVD 88 DATUM)



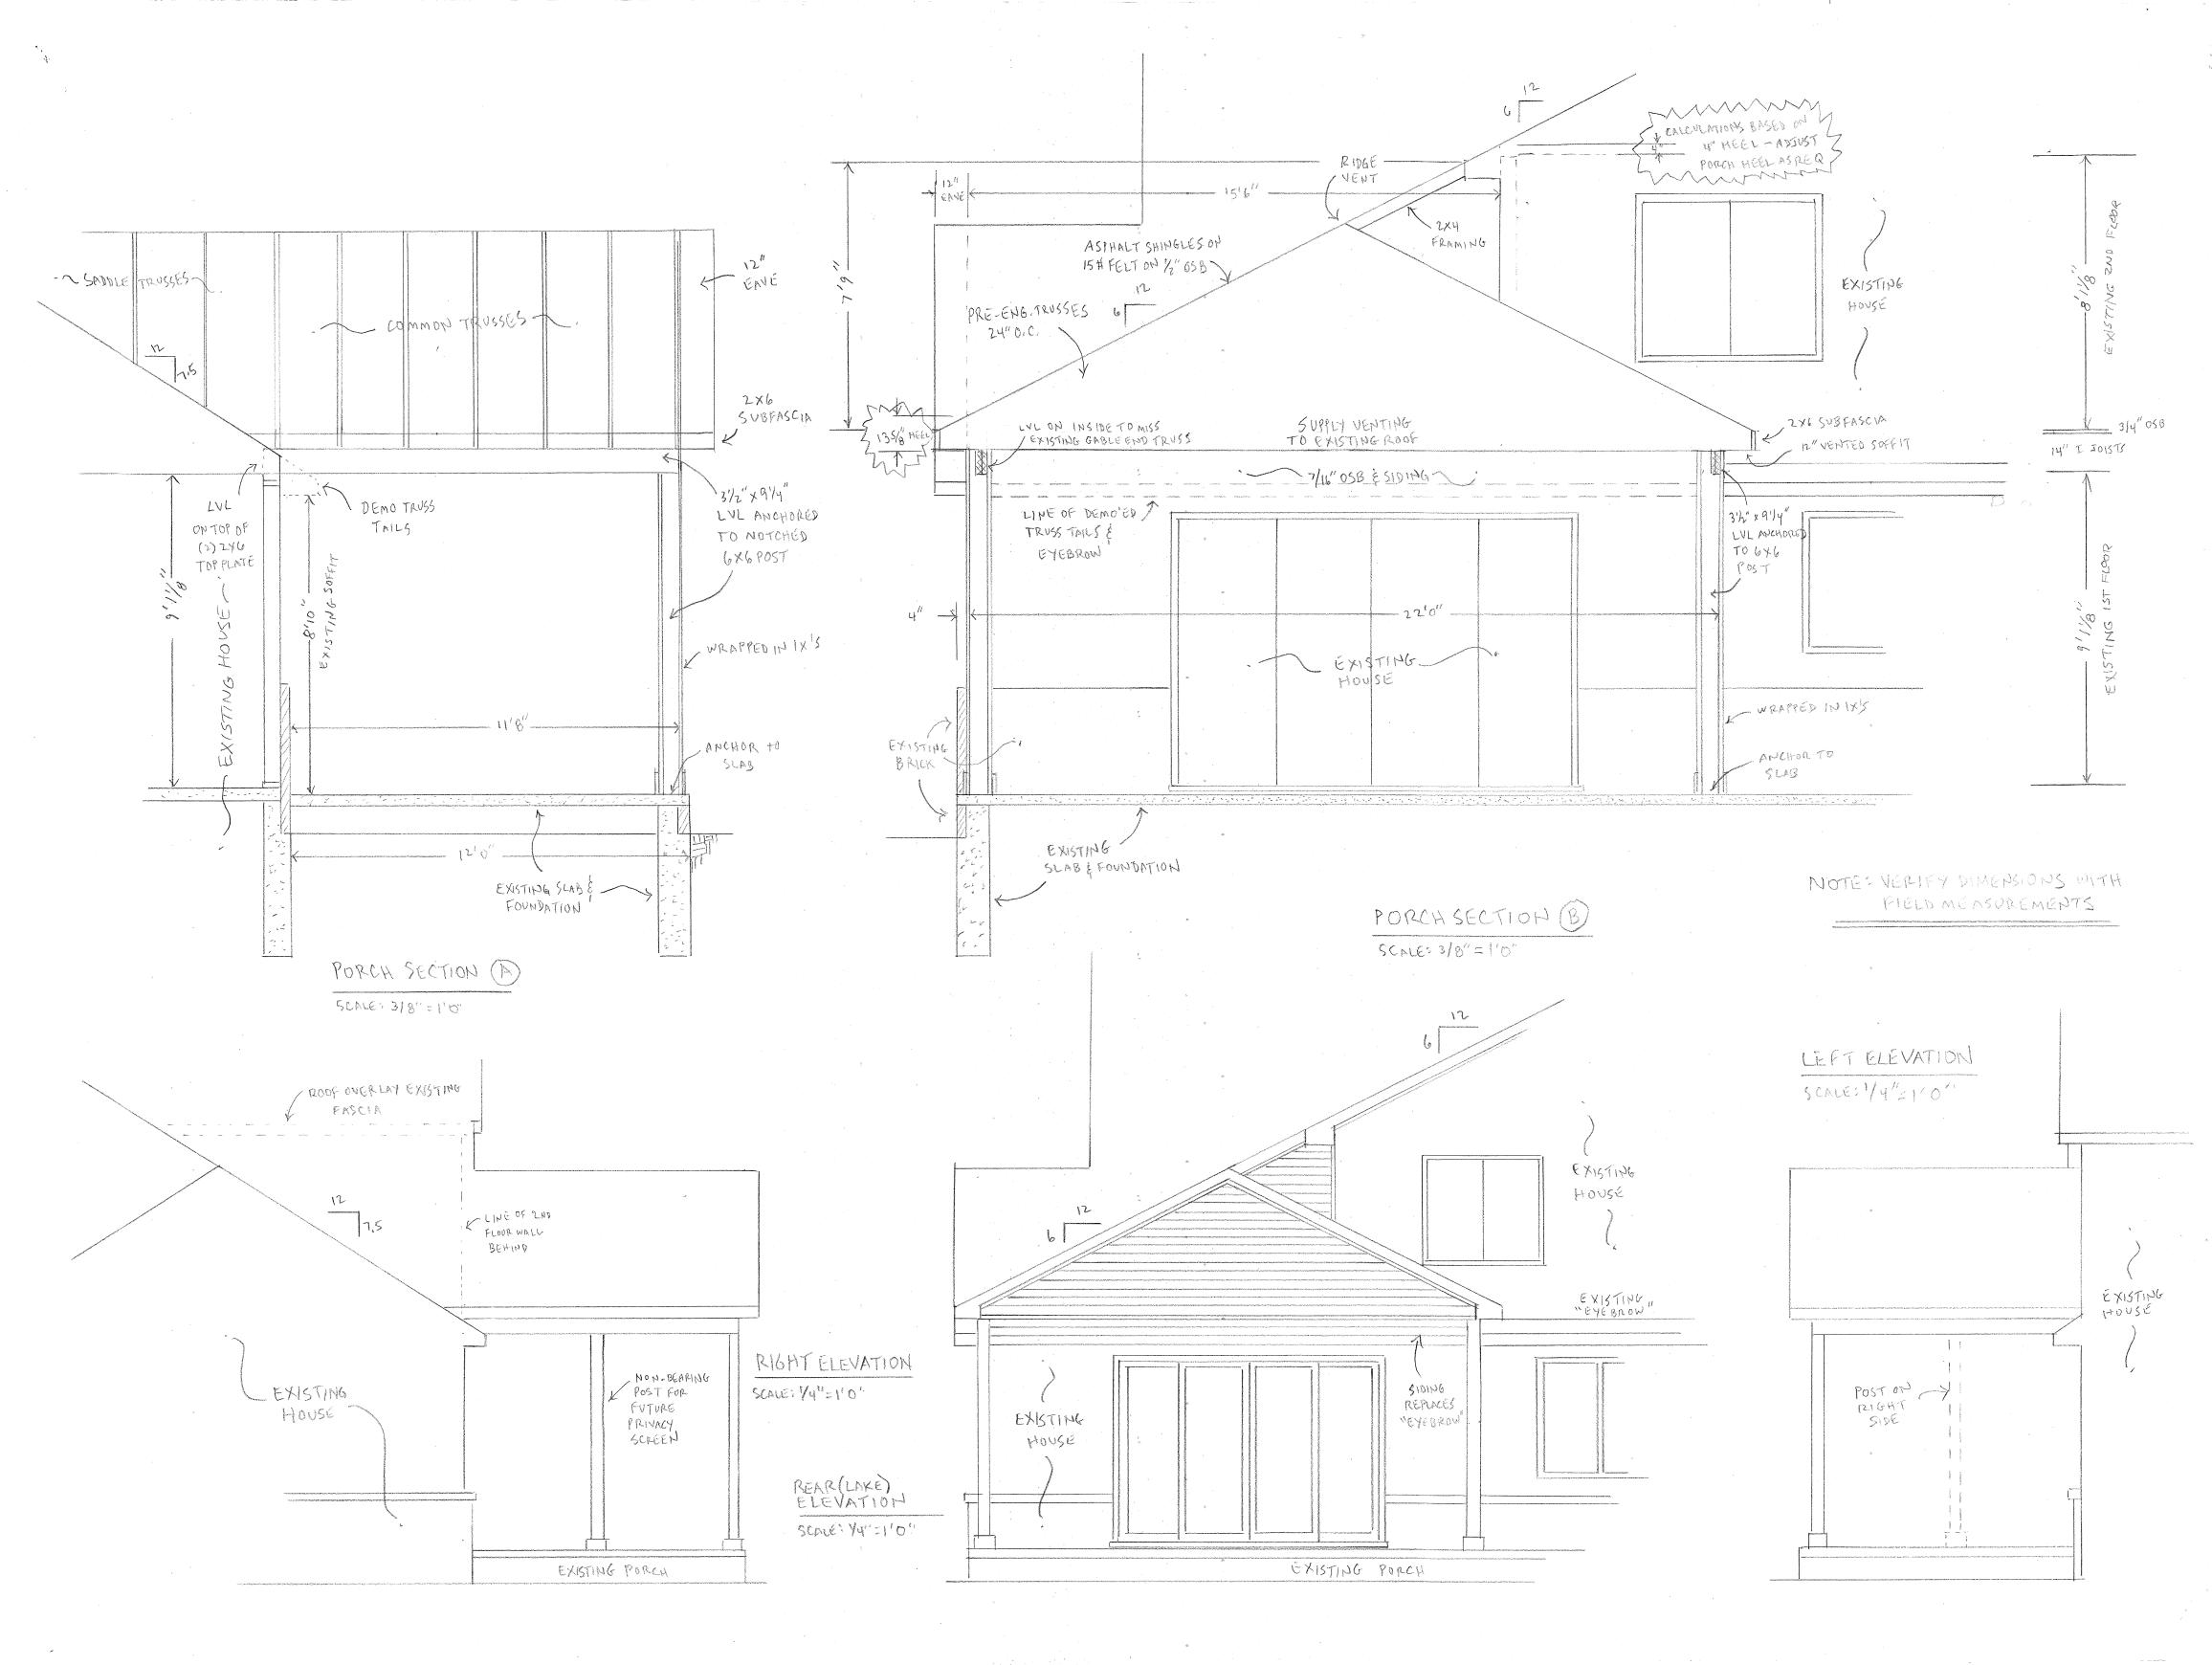

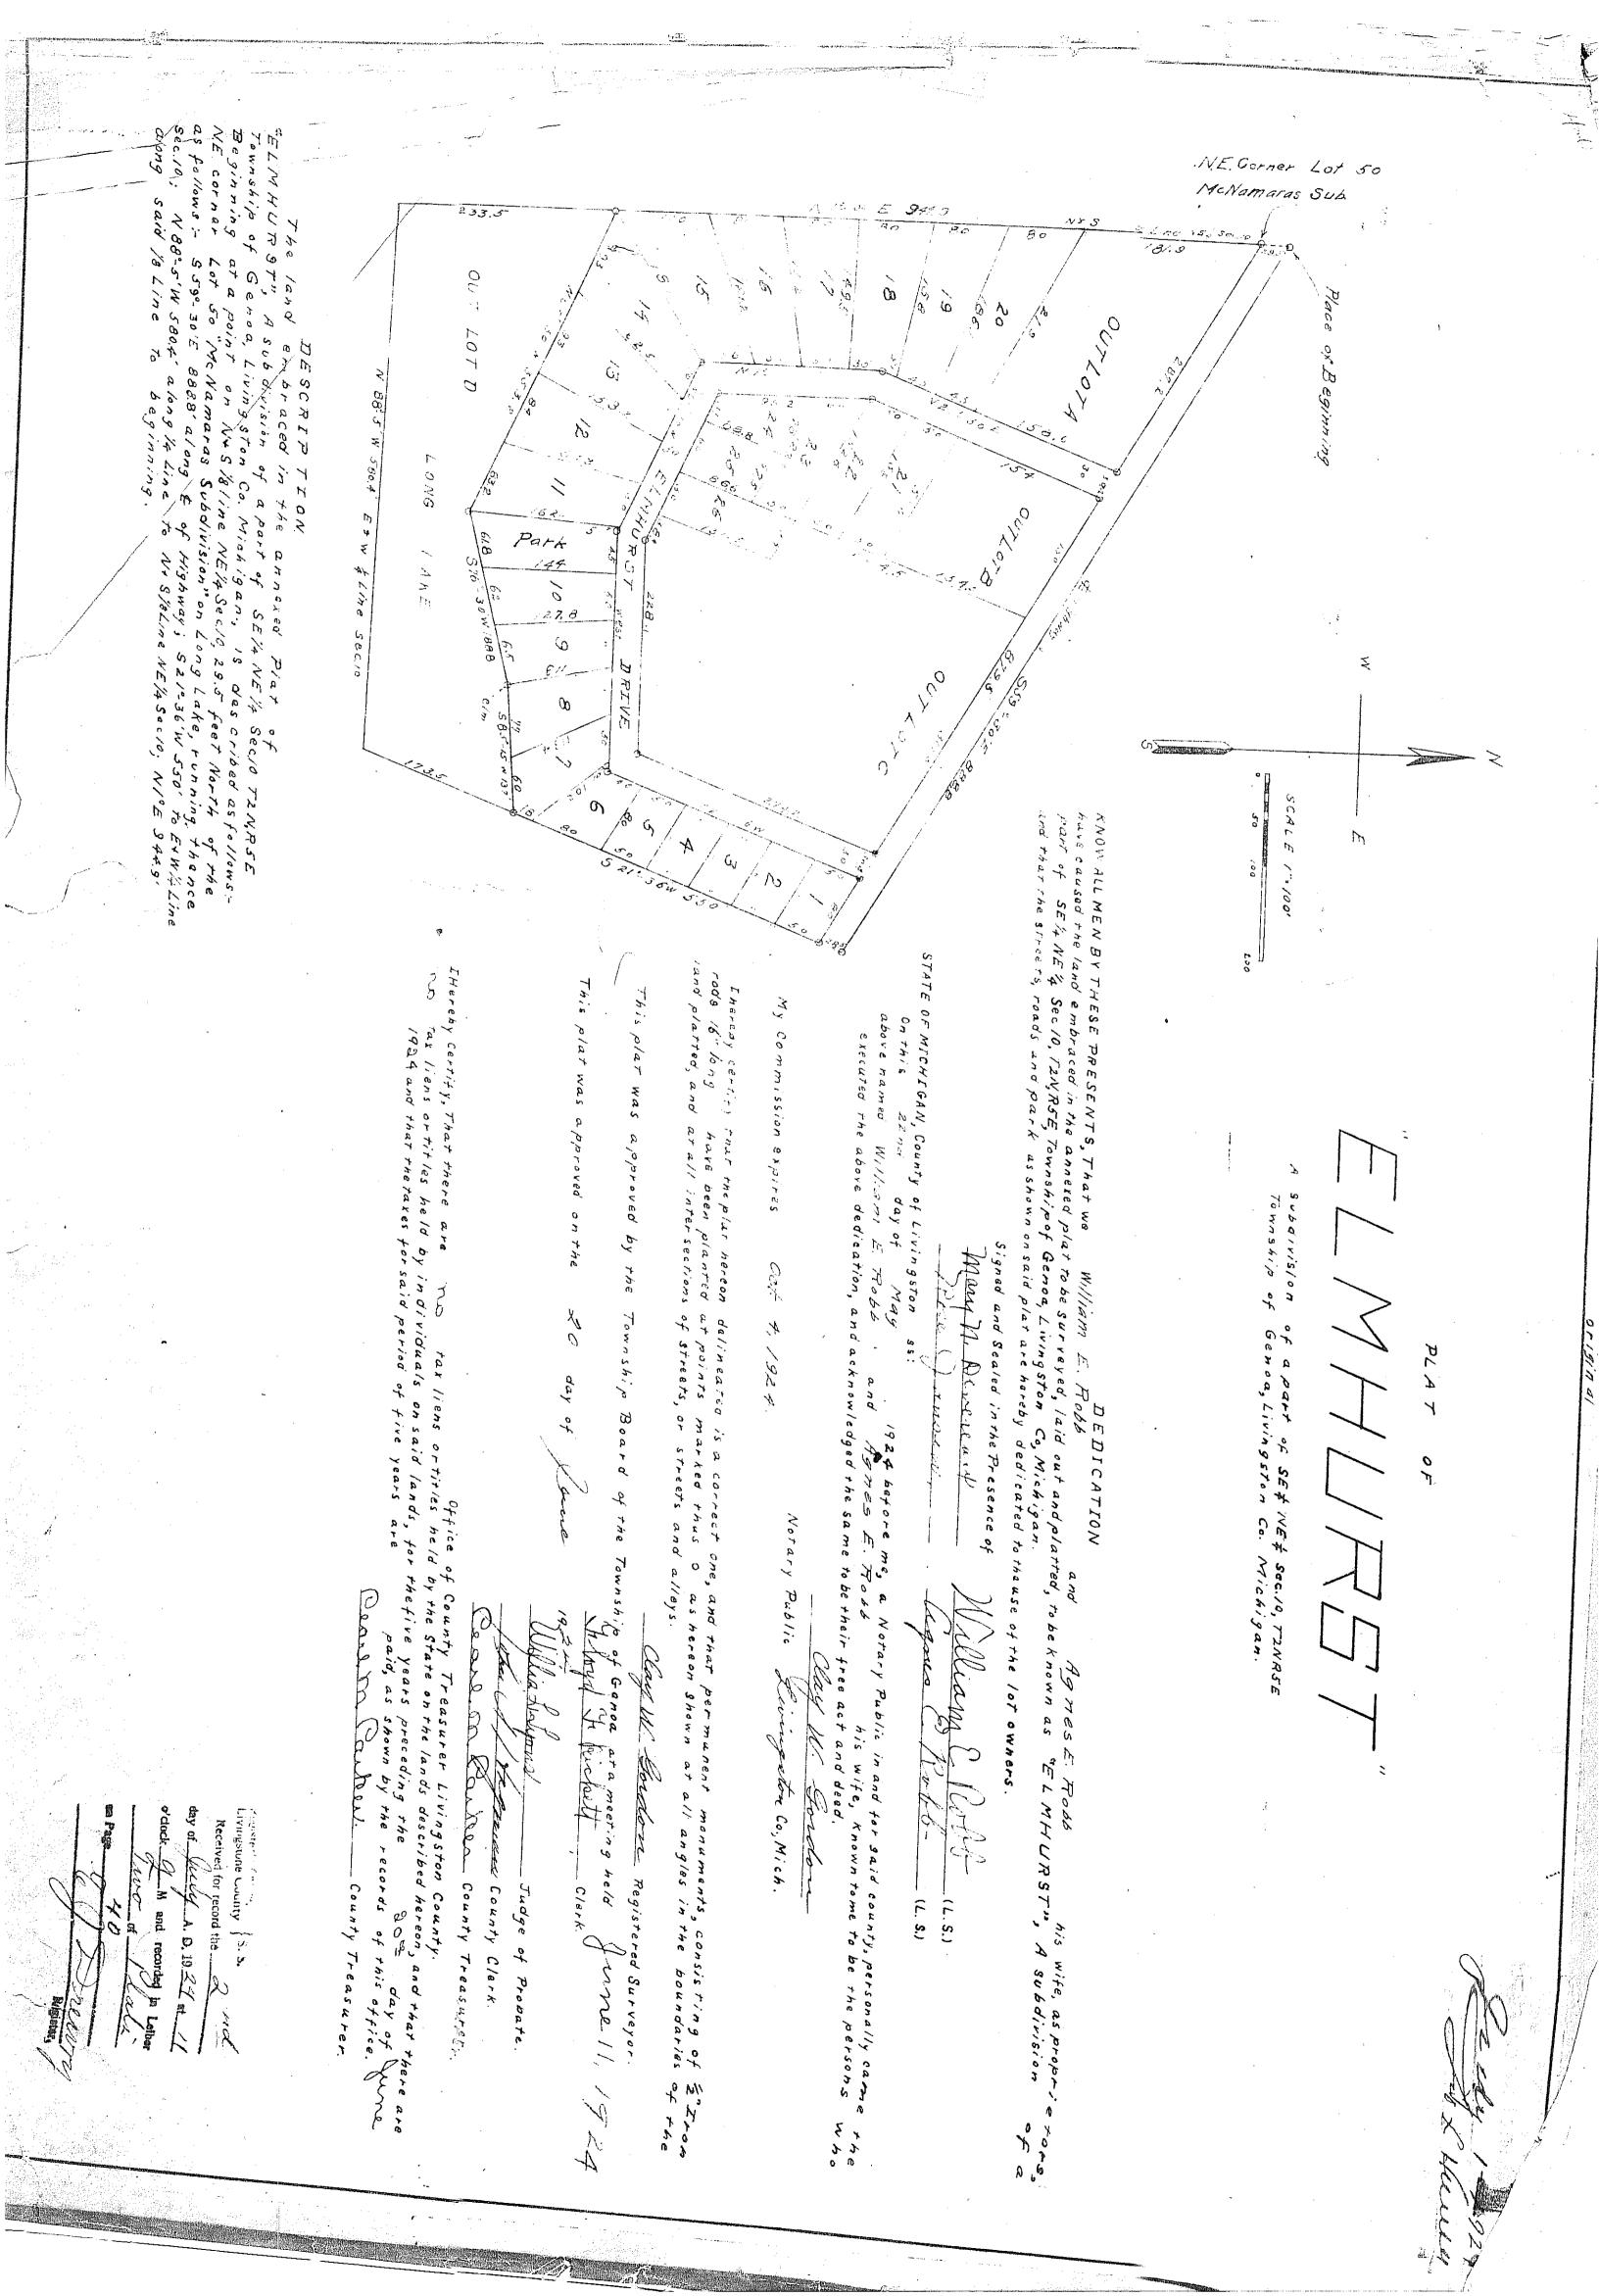

| raicei Number: 4/11-10-20 | 2-036 | | | | | | | | | | |
|---|---|-----------------------------------|--|-----------------------------|--------------|---------------|--|-----------------|-----------------------|--------------|--------------------|
| Grantor | Grantee | | | Sale Price | Sale Date | Inst. Type | Terms of Sale | Liber & Page | | erified 7 | Prcnt Trans |
| HASKINS TERRY & LUANN TRUS | LONG FAMILY TRUS | ST | | 280,000 | 06/14/2018 | WD | 03-ARM'S LENGTH | 2018R- | -016004 Bt | JYER/SELLER | 100. |
| BUTCHER, DAVID & GEORGIA T | BUTCHER DAVID & | GEOR | RGIA RI | 1 | 09/28/2017 | QC | 14-INTO/OUT OF TRUS | T 2017R- | -028585 Bt | YER/SELLER | 0. |
| BUTCHER DAVID & GEORGIA RI | HASKINS TERRY & | LUAN | 1N | 200,000 | 09/28/2017 | WD | 03-ARM'S LENGTH | 2017R- | -028587 Bt | YER/SELLER | 100. |
| HASKINS TERRY & LUANN | HASKINS TERRY & | LUAN | IN TRUS | 1 | 09/28/2017 | QC | 14-INTO/OUT OF TRUS | T 2017R- | -028589 Bt | JYER/SELLER | 0. |
| Property Address | I | Clas | ss: RESIDE | NTIAL-IMPR | OV Zoning: I | LRR Bui | lding Permit(s) | Dat | e Numbe | r S | tatus |
| 1342 ELMHURST DR | | Scho | ool: HOWEL | L PUBLIC S | CHOOLS | Res | idential New Construc | cti 08/08/ | ′2018 P18-1 | 55 7 | FINAL BL |
| | | P.R. | .E. 100% 0 | 3/11/2020 | | AME | NDED | 11/01/ | ′2017 A17-1 | 95 N | O START |
| Owner's Name/Address | | MAP | #: V24-24 | : | | HOM | E | 10/25/ | ′2017 P17-1 | 95 N | O START |
| LONG FAMILY TRUST | | | 2025 Est I | CV 919,063 | TCV/TFA: 2 | 88.02 DEM | 0 | 10/02/ | | | O START |
| 1342 ELMHURST DR | | | Improved | Vacant | | | ates for Land Table 4 | | | | |
| HOWELL MI 48843-9139 | | | Public | | | | * Fact | | | | |
| | | | Improvemen | ts | Descrip | tion Fro | ontage Depth Front | Depth Rate | | son | Value |
| Tax Description | | I | Dirt Road | | A LAKEF | | 40.00 130.00 1.0000 | | | | 136,000 |
| SEC. 10 T2N, R5E, ELMHURST | ' т.ОТ 13 | 1 1 | Gravel Roa Paved Road | | B SURPLI | | 53.00 130.00 1.0000 nt Feet, 0.28 Total A | |) 100 al Est. Land | Nalue = | 121,900 257,900 |
| COMB.AND ALSO A PORTION OF ELMHURST COMM AT SE COR OF ELMHURST TH S29*24'52"W 54 101.7 FT TH N35*15'56"E 57 S65*30'00"E 93.03 FT ALON OF SAID LOT 13 TO POB FR O CORR LEGAL 9/11 Comments/Influences | LOT 13 OF SAID .30 FT TH NW'LY '.05 FT TH IG THE S'LY LINE | | Storm Sewe Sidewalk Water Sewer Electric Gas Curb Street Lig Standard U Undergroun | hts tilities d Utils. | | | | | | | |
| | | I | Topography Site Level Rolling Low High | of | | | | | | | |
| | | I S V H X V | Landscaped Swamp Wooded Pond Waterfront Ravine Wetland | | | | | | | | |
| | | | Wetrand Flood Plai | n | Year | Lan | . | Assessed | Board c | | |
| | | | REFUSE | | | Valu | | Value | Revie | w Othe | |
| | | Who | When | What | 2025 | 129,00 | 0 330,500 | 459,500 | | | 422,037 |
| | 07/40/2040 | | 07/10/201 | 9 INSPECTE | D 2024 | 99,80 | 0 331,600 | 431,400 | | | 422,037 |
| 4711-10-202-038 | 07/18/2019 | | | | - | 33,00 | 001,000 | 101, 100 | | | 722,037 |
| 4711-10-202-038 The Equalizer. Copyright Licensed To: Township of G | (c) 1999 - 2009. | JB | 11/14/201 | 8 INSPECTE 7 INSPECTE | D 2023 | 99,80 | · | 409,000 | | | 401,940 |

Parcel Number: 4711-10-202-038 Jurisdiction: GENOA CHARTER TOWNSHIP County: LIVINGSTON

Printed on 08/09/2024

^{***} Information herein deemed reliable but not guaranteed***

| X Single Family Mobile Home Town Home Duplex A-Frame X Savestrough X Insulation Offront Overhang Dother Overhang A-Frame X Gas Wood Coal Steam Cook Top Dishwasher Garbage Disposa Bath Heater Vent Fan | Interior 2 Story 49 CCP (1 Story) Car Capacity: Class: C |
|--|--|
| X Wood Frame X Drywall Plaster Building Style: C Trim & Decoration Yr Built Remodeled Ex X Ord Min Wall/Floor Furnace Electric Baseboard Electr | Exterior 2 Story Prefab 1 Story Prefab 2 Story Heat Circulator Raised Hearth Wood Stove Stone Ven.: 0 Common Wall: 1 Wall Foundation: 42 Inch Finished ?: Auto. Doors: 0 Mech. Doors: 0 |
| Zol8 O | Class: C Effec. Age: 3 Floor Area: 3,191 Total Base New: 474,994 Total Depr Cost: 460,741 Storage Area: 864 No Conc. Floor: 0 Bsmnt Garage: |
| 1st Floor 2nd Floor Kitchen: (12) Electric Central Vacuum Security System | Estimated T.C.V: 661,163 Carport Area: |
| No./Qual. of Fixtures Cost Est. for Res. (1) Exterior Ex. X Ord. Min (11) Heating System | Bldg: 1 Single Family C Cls C Blt 2018 em: Forced Heat & Cool SF Floor Area = 3191 SF. |
| Wood/ billingto (0) certings No of Eloc Outloto | con/Comb. % Good=97/100/100/100/97 rior Foundation Size Cost New Depr. Cost ag Crawl Space 192 ag Crawl Space 244 |
| ManyLargeBasement: 0 S.F.2 Fixture Bath1 StorySidinX Avg.X Avg.Crawl: 2037 S.F.Softener, Auto2 StorySidinFewSmallSlab: 0 S.F.Softener, Manual1 StorySidinWood SashHeight to Joists: 0.0Solar Water Heat1 StorySidin | Crawl Space 330 Crawl Space 770 Crawl Space 144 |
| Metal Sash Vinyl Sash Double Hung Horiz. Slide Metal Sash Vinyl Sash Conc. Block Poured Conc. Separate Shower Ceramic Tile Floor Plumbing | · |
| Casement Double Glass Patio Doors Storms & Screens Casement Double Glass Patio Doors Storms & Screens Storms & Screens | 2 9,621 9,332 2 1,967 1,908 49 1,530 1,484 |
| (3) Roof Recreation SF Living SF Living SF Walkout Doors (B) 1 1000 Gal Septic Base Cost CPP CPP CPP CATAGORD CATAGORD CPP CATAGORD CPP CATAGORD CPP CATAGORD CATAGORD CPP CATAGORD CATAGORD CPP CATAGORD CPP CATAGORD CPP CATAGORD CATAGORD CPP CATAGORD CATAGORD CPP CATAGORD CPP CATAGORD CPP CATAGORD CATA | 600 9,552 9,265 Siding Foundation: 42 Inch (Unfinished) 864 34,171 33,146 |
| X Asphalt Shingle (10) Floor Support Unsupported Len: Walkout Doors (A) 2000 Gal Septic 2000 | |

^{***} Information herein deemed reliable but not guaranteed***



GENOA CHARTER TOWNSHIP VARIANCE APPLICATION 2911 DORR ROAD | BRIGHTON, MICHIGAN 48116

Pm

(810) 227-5225 | FAX (810) 227-3420

| Case # 24-25 Mee | eting Date: August 20, 2024 @ 6:30 |
|---|--|
| PA PA | AID Variance Application Fee |
| \$215.00 for Residential \$300.00 for Si | gn Variance \$395.00 for Commercial/Industrial |
| Applicant/Owner: GERARD DElyon | Email: GAELYON'S SEC GLOSAL NOL |
| Property Address: 7022 Linksey Drive | Phone: 517-304-2559 |
| | Tax Code: 11-13-101-001 |
| ARTICLE 23 of the Genoa Township Zoning Ordinance de Zoning Board of Appeals. | scribes the Variance procedure and the duties of the |
| Each application for Variance is considered individually by change the Zoning Ordinance or grant relief when it is pos provide relief where due to unique aspects of the propert land results in practical difficulties or unnecessary hardshi | ssible to comply with the Zoning Ordinance. It may |
| The applicant is responsible for presenting the information much of the necessary information is gathered through the gathered by on-site visits, other sources, and during the Z township staff may visit the site without prior notification | e completed application, other information may be |
| Failure to meet the submittal requirements and properly improvements may result in postponement or denial of t | stake the property showing all proposed |
| Please explain the proposed variance below: | nis petition. |
| Variance requested/intended property modifications:_ | BUILD A STEEL GARAGE/STORGE BUILDING |
| ON My People & Berlins My House | |
| | |
| | |

Please note that the packet and staff report for your scheduled Zoning Board of Appeals meeting will be available to review at https://www.genoa.org/government/boards/zoningboard five days prior to the meeting.

The following is per Article 23.05.03 of the Genoa Township Ordinance:

<u>Criteria Applicable to Dimensional Variances</u>. No variance in the provisions or requirements of the Ordinance shall be authorized by the Board of Appeals unless it is found from the evidence that <u>all</u> of the following conditions exist:

Under each please indicate how the proposed project meets each criteria.

<u>Practical Difficulty/Substantial Justice.</u> Compliance with the strict letter of the restrictions governing area, setbacks, frontage, height, bulk, density, or other dimensional provisions would unreasonably prevent the use of the property. Granting of a requested variance or appeal would do substantial justice to the applicant as well as to other property owners in the district and is necessary for the preservation and enjoyment of a substantial property right similar to that possessed by other properties in the same zoning district and vicinity of the subject parcel.

| It would Allow ME TO HONG A MUCH NEWSON STORAGE GALAGE ON MY PROPERTY IN THE ONLY Place it would work Doe to Topochaphy |
|--|
| Place it would work Doe to Topochaphy |
| |
| <u>Extraordinary Circumstances.</u> There are exceptional or extraordinary circumstances or conditions applicable to the property or the intended use which are different than other properties in the same zoning district or the variance would make the property consistent with the majority of other properties in the vicinity. The need for the variance was not self-created by the applicant. |
| DUC TO THE TERRELAPHY OF MY LAMB THIS IS THE ONLY SPOT THAT WELKS FOR MY |
| |
| Public Safety and Welfare. The granting of the variance will not impair an adequate supply of light and air to adjacent property or unreasonably increase the congestion in public streets, or increase the danger of fire or endanger the public safety, comfort, morals or welfare of the inhabitants of the Township of Genoa. |
| |
| Impact on Surrounding Neighborhood. The variance will not interfere with or discourage the appropriate development, continued use, or value of adjacent properties and the surrounding neighborhood. |
| Attendance by the applicant is required at the Zoning Board of Appeals meeting. |
| Accordance by the applicant is required at the 20mmg Board of Appeals meeting. |
| Any Variance not acted upon within 12 months from the date of approval is invalid and must receive a renewal from the Zoning Board of Appeals (ZBA). |
| After the decision is made regarding your Variance approval a land use permit will be required with additional site plans and construction plans. |



2911 Dorr Road Brighton, MI 48116 810.227.5225 810.227.3420 fax genoa.org

MEMORANDUM

TO: Genoa Township Zoning Board of Appeals

FROM: Carrie Aulette, Zoning Official

DATE: August 13, 2024

RE: ZBA 24-25

STAFF REPORT

File Number: ZBA# 24-25

Site Address: 7022 Lindsey Drive

Parcel Number: 4711-13-101-001

Parcel Size: .970 Acres

Applicant: Gerard and Jo Ann Delyon, 7022 Lindsey Drive, Brighton

Property Owner: Same as Applicant

Information Submitted: Application, site plan, conceptual drawings

Request: Dimensional Variance

Project Description: Applicant is requesting a front yard variance to construct a steel

accessory building.

Zoning and Existing Use: LDR (Low Density Residential) Single Family Dwelling located

on property.

Other:

Public hearing was published in the Livingston County Press and Argus on Sunday August 4, 2024 and 300 foot mailings were sent to any real property within 300 feet of the property in accordance with the Michigan Zoning Enabling Act.

Background

The following is a brief summary of the background information we have on file:

- Per assessing records the existing home on the parcel was constructed in 1979.
- The parcel is serviced by well and septic.
- See Assessing Record Card.

The proposed project is to construct a detached accessory building. In order to construct the accessory building as proposed, the applicant is required to obtain a front yard variance. The location of the property is on a corner lot, thus leaving the applicant with two (2) front yards. Per Article 11.04.02 Accessory Buildings are not allowed in any front yard in this particular Zoning District. The applicant should demonstrate the building is not located in the Drain Easement shown on the Plat Map.

SUPERVISOR

Bill Rogers

CLERK

Paulette A. Skolarus

TREASURER

Robin L. Hunt

TRUSTEES

Jean W. Ledford H. James Mortensen Terry Croft Diana Lowe

MANAGER

Kelly VanMarter

Variance Requests

The following is the section of the Zoning Ordinance that the variance is being requested from:

11.04.02 **Accessory Buildings**

- (a) Restrictions in Front Yard: Detached accessory buildings shall not be erected in any front yard, except as follows:
 - (1) Waterfront lots in the Lakeshore Resort Residential District, provided the front setback is not less than ten (10) feet.
 - (2) Lots of at least five (5) acres in the AG or CE District when the front setback is equal to or greater than the average setback of established buildings on adjoining lots or seventy-five (75) feet, whichever is greater, as determined by the Zoning Administrator. If both of the adjacent lots are undeveloped, then front yard accessory buildings are permitted with a minimum front yard setback of two hundred (200) feet.
 - (1) In the case of attached residential dwelling complexes, detached parking garages or carports may be permitted in the non-required front yard provided the Planning Commission approves the site plan, elevation drawings and construction materials. In reviewing such structures, the Planning Commission shall consider the impact of headlights and views from nearby public streets and adjacent properties.

<u>Summary of Findings of Fact-</u> After reviewing the application and materials provided, I offer the possible findings of fact for your consideration:

Please note that in order for a variance to be approved it has to meet all of the standards in 23.05.03.

- (a) Practical Difficulty/Substantial Justice Strict compliance with the front yard setback would prevent the applicant from constructing the accessory building as proposed. Strict compliance with this ordinance would not unreasonably prevent the use of the property and would not offer substantial justice. Staff could not find supporting evidence that there are any other accessory buildings in the immediate area within the same zoning district.
- **(b)** Extraordinary Circumstances The exceptional or extraordinary condition of the property is the topography of the lot. The applicant has stated that the back of the lot drops off making this the only viable spot for this accessory building. The need for the variance is not self-created however, the applicant should demonstrate this request is the least amount necessary by possibly moving the structure closer to the house.
- (c) Public Safety and Welfare The granting of the variance will not impair an adequate supply of light and air to adjacent property or unreasonably increase the congestion in public streets, or increase the danger of fire or endanger the public safety, comfort, morals or welfare of the inhabitants of the Township of Genoa. The construction of this structure could have an impact on public safety if the site line is not maintained on Hubert Road.
- (d) Impact on Surrounding Neighborhood The proposed variance would have little or no impact on the appropriate development, continued use, or value of adjacent properties and the

surrounding neighborhood. It is noted that not many homes in the area have accessory buildings on their lots.

Recommended Conditions

If the Zoning Board of Appeals grants the variance requests staff recommends the following conditions be placed on the approval.

1. The structure should be guttered with downspouts.



LOT LAYOUT

PARCEL ID 4711-13-101-001 7022 Lindscy Drive Brighted, Michigal 48114 GERAD Delyal

1904 Flen Livosing Read Linosey Rens 127.62 Ft House 130 F+ HUBGET READ 236. CGFF 115.4+ 20102 76 FEET FREN HUBILI RD 179.3ft 157.56 F+

20' WIDE FRAME

'CARPORT STYLE' METAL BUILDING GENERICS



SCOPE OF PLANS:

- 1. TO PROVIDE STRUCTURAL DESIGN FOR A VARIETY OF PRE-FAB METAL BUILDINGS PER THE SPECIFIED DESIGN LOADS, AND APPLICABLE BUILDING CODES.
- 2. DOES NOT PROVIDE ANY ARCHITECTURAL, SITE, ZONING, HVAC. ELEC, MECH DESIGN OR REQUIREMENTS. THESE ITEMS MUST BE ADDRESSED BY THEIR RESPECTIVE PROFESSIONALS IN CHARGE,
- 3. DOES NOT PROVIDE ANY DOOR OR WINDOW DESIGN INFORMATION, THOSE SHALL BE ADDRESSED BY DOOR AND WINDOW MANUFACTURER.
- 4. THESE DOCUMENT SHALL NOT BE USED TO PERMIT OR JUSTIFY DESIGN OF AS-BUILT / EXISTING STRUCTURES OR BUILDINGS BUILT WITHOUT A PERMIT.

GENERAL DESIGN NOTES

- 1. THESE STRUCTURES ARE DESIGNED AS RISK CATEGORY I (NON-HABITABLE), UTILITY / STORAGE / PRIVATE GARAGE / SHED TYPE BUILDINGS - THAT ONLY DESIGNED TO RESIST THE DEAD LOADS, LIVE LOADS, AND WIND LOADS LISTED UNDER "STRUCTURAL DESIGN CRITERIA", ANY ADDITIONAL LOADINGS WITHOUT RE-DESIGN OR ENGINEERING CONSULTATION SHALL NOT BE PERMITTED.
- 2. ALL MATERIALS IDENTIFIED BY A MANUFACTURER NAME MAY BE SUBSTITUTED WITH MATERIAL EQUAL OR EXCEEDING ORIGINAL.
- 3. ALL WELDED CONNECTIONS SHALL BE SHOP WELDED CONNECTIONS, FIELD WELDING IS NOT PERMITTED NOR REQUIRED.
- 4. ALL STRUCTURAL LIGHT GAUGE TUBING AND CHANNELS SHALL BE: ASTM A500 GRADE C OR EQUAL: Fy = 50 KSI Fu = 65 KSI
- 5. GYPSUM BOARD OR DRYWALL FINISH OR ANY BRITTLE BASE MATERIAL IS NOT CONSIDERED OR ACCOUNTED FOR ON THE DESIGN CRITERIA OF THIS. STRUCTURE, U.N.O.

CUSTOMER INFORMATION

STRUCTURAL DESIGN CRITERIA

ALL CONSTRUCTION SHALL BE PROVIDED IN ACCORDANCE WITH THE PREVAILING CODES LISTED BELOW AND ALL APPLICABLE LOCAL REQUIREMENTS.

PREVAILING CODE: MBC 2015 MINIMUM DESIGN STANDARD: ASCE 7-10

OCCUPANCY GROUP: U (CARPORT / UTILITY / GARAGE / SHED) CONSTRUCTION TYPE:

RISK CATEGORY:

1. ROOF DEAD LOAD (D)

2. ROOF LIVE LOAD (Lr) Lr = 20 TO 61 PSF

(VARIES BASED ON FRAME SPACING AND DESIGN OPTIONS!

DESIGN OPTIONS!

Pf = 20 TO 61 PSF

ls = 0.80

Ct = 1.2

Ce = 1.0

Cs = 1.0

Pm = 20

I (NON-HABITABLE)

2.0 PSF (COLLATERAL)

SNOW LOAD (S) GROUND SNOW LOAD Pg = 20 TO 90 PSF IVARIES BASED ON FRAME SPACING AND

IMPORTANCE FACTOR THERMAL FACTOR **EXPOSURE FACTOR** ROOF SLOPE FACTOR FLAT ROOF SNOW LOAD SLOPED ROOF SNOW LOAD Ps = 20 TO 61 PSF MINIMUM SNOW LOAD.

4. WIND LOAD (W) **EXPOSURE**

DESIGN WIND SPEED Vull = 105 TO 180 MPH IVARIES BASED ON FRAME SPACING AND DESIGN OPTIONS!

C

le = 1.00

5. SEISMIC LOAD (E) DESIGN CATEGORY **IMPORTANCE FACTOR**

ASD LOAD COMBINATIONS:

1. D + (Lr OR S) 2. D + (0.6W OR ±0.7E)

3. D + 0.75 (0.6W OR ±0.7E) + 0.75 (Lr OR S)

4. 0.6D + (0.6W OR ±0.7E)

CONTACT INFORMATION

FOR QUESTIONS OR INFORMATION NEEDED PLEASE. CONTACT THE METAL BUILDINGS MANUFACTURER LISTED ON PLANS. ENGINEER OF RECORD REQUIRES AUTHORIZATION FROM THE METAL BUILDINGS MANUFACTURER TO ADDRESS ANY QUERIES

THE INFORMATION CONTAINED IN THESE DRAWINGS IS THE SOLE PROPERTY OF METAL BUILDING MANUFACTURER LISTED ON THIS PAGE, ANY REPRODUCTION IN PART OR WHOLE WITHOUT THE WRITTEN PERMISSION OF METAL BUILDING MANUFACTURER LISTED BELOW IS PROHIBITED, LEGAL ACTION WILL BE TAKEN AS NECESSARY AS A RESULT.

ANY REQUESTS, CHANGES, MODIFICATIONS REVISIONS TO INFORMATION PROVIDED IN THIS DOCUMENT WILL REQUIRE A COMPLETELY SEPARATE SITE-SPECIFIC SET OF PLANS: INQUIRE WITH THE LISTED METAL BUILDING MANUFACTURER.

STRUCTURAL SHEET INDEX

| CO | VER SHEET | 1 |
|------|-----------------------------|------------|
| SCH | HEDULES & MEMBER - SECTIONS | 2 |
| FRA | ME SECTIONS & DETAILS | 3A, 3B |
| SPA | CING SCHEDULES & ENCLOSURE | NOTES 4 |
| PUR | LIN & GIRT SCHEDULES | 5 |
| SHE | ATHING OPTIONS | 6 |
| SIDE | EWALL FRAMING & OPENINGS | |
| END | WALL FRAMING & OPENINGS | 8A, 8B |
| COF | RNER BRACING DETAILS | 9 |
| OPT | IONAL LEAN-TO ADDITION | 10 |
| FOU | NDATION OPTIONS | 114 TO 110 |

Yasein

Omar Abu-Omar Abu-Yasein Digitally signed by Date: 2024.02.28

09:46:47 -05'00' BUILDING INFORMATION CERTIFICATION VALIDITY NOTICE ☐ A-FRAME FRAME TYPE: ☐ REGULAR

DATE OF PLANS EXPIRATION: FEB 23 2025

CERTIFICATION ON THESE DRAWINGS IS VALID FOR ONE YEAR FROM DATE OF ISSUE MANUFACTURED BY:



457 N. Broadway. Joshua, TX 76058 1-866-730-9865

ENGINEERED BY:



CIVIL · STRUCTURAL DRAWING INFORMATION

PROJECT: 20' Wide

OCATION: STATE OF MICHIGAN

PROJECT NO.: 033-24-0434

COVER SHEET

1/11 SHEET NO .:

CHECKED BY: OAA DATE: 1/25/24

LEGAL INFORMATION

- ANY DUPLICATION OF THIS DRAWING IN WHOLE OR PART IS STRICTLY FORBIDDEN. ANYONE DOING SO WILL BE PROSECUTED UNDER THE FULL EXTENT OF THE LAW. DRAWINGS VALID UP TO 1 YEAR FROM DATE OF ISSUE.



STAMP EXPIRY: MAR 24 2026 DATE SIGNED: FEB 23 2024

ADDRESS 7022 Lindsey Rd Brighton MI 48114

Gerard Delyon

DESIGN LOADS GROUND SNOW: 30 ROOF LIVE LOAD: 20 BASIC WIND SPEED: 130

WIDTH: 20 HEIGHT:

☐ FULL ENCLOSURE

☐ PARTIAL OPEN.

TABLE 21: MEMBER PROPERTIES

| | TABLE 2.1: MEMIDER PROPERTIES | | | | | |
|-----|----------------------------------|---|------------|--|--|--|
| NO. | LABEL | PROPERTY | DETAIL NO. | | | |
| 1 | COLUMN POST | 2.5" X 2.5" X 14GA TUBE | 1 | | | |
| 2 | ROOF BEAM | 2.5" X 2.5" X 14GA TUBE | 1 | | | |
| 3 | BASE RAIL | 2.5" X 2.5" X 14GA TUBE | 1 | | | |
| 4 | PEAK BRACE | 2.5" X 2.5" 14GA CHANNEL | 4 | | | |
| 5 | KNEE BRACES | 2.5" X 1.5" 14GA CHANNEL | 4 | | | |
| 6 | CONNECTOR SLEEVE | 2.25" X 2.25" X 12GA TUBE | 2 | | | |
| 7 | BASE ANGLE | 2" X 2" X 3" LG. 3/16" ANGLE | 10 | | | |
| В | PURLIN | 4" X 1" X 14GA / 18GA HAT CHANNEL | 5 | | | |
| 9 | GIRT | 4" X 1" X 14GA / 18GA HAT CHANNEL | 5 | | | |
| 9A | OPT. END WALL GIRT | 2.5" X 1.5" 14GA CHANNEL | 1 | | | |
| 10 | SHEATHING | 29 GA CORRUGATED SHEET | 8 | | | |
| 11 | END WALL POST | 2.5" X 2.5" X 14GA TUBE | 1 | | | |
| 12 | DOOR POST | 2.5" X 2.5" X 14GA TUBE | 1 | | | |
| 13 | SINGLE HEADER | 2.5" X 2.5" X 14GA TUBE | 1 | | | |
| 14 | DOUBLE HEADER | DBL. 2.5" X 2.5" X 14GA TUBE | 1 | | | |
| 15 | SERVICE DOOR / WINDOW FRAMING | 2.5" X 2.5" X 14GA TUBE | 1 | | | |
| 16 | ANGLE BRACKET | 2" X 2" X 2" LG. 14GA ANGLE | 7 | | | |
| 17 | STRAIGHT BRACKET | 2" X 2" X 4" LG. 14GA PLATE | 6 | | | |
| 18 | PB SUPPORT | 2.5" X 2.5" X 14GA TUBE | 1 | | | |
| 19 | DIAGONAL BRACE | 2" X 2" X 14 GA TUBE | 3 | | | |
| 20 | GABLE BRACE | 2" X 2" X 14 GA TUBE | 3 | | | |
| 21 | DB BRACKET | 2.25" X 2.25" X 6" LG. 14GA ANGLE | 9 | | | |
| 22 | TRUSS SPACER | 2.5" X 2.5" X 14GA TUBE | 1 | | | |
| 23 | ALL FASTENERS | #12 X 1" SELF-DRILL SCREWS (ESR-2196 OR EQ) W/ NEOPRENE/STEEL WASHER | | | | |

TABLE 2.2: SHEATHING FASTENER SCHEDULE

| TABLE 2.2. CHEATTING TABLE SCIEDULE | | | | | | |
|-------------------------------------|---------------|-----------|-----------|-----------|--|--|
| LOCATION | CORNER PANELS | SIDE LAPS | EDGE LAPS | ELSEWHERE | | |
| SPACING | 9" C/C | MiN. 1 | 4½" C/C | 9" C/C | | |

FASTENER TYPE: #12X1" SELF-DRILL SCREWS (ESR-2196 OR EQ) W/

NEOPRENE/STEEL WASHER

"SEE TYP. SHEATHING FASTENER SCHEDULE DIAGRAM ON PAGE 6.



SCALE: NTS

THICKNESS = 14GA



THICKNESS = 12GA

2.5" X 2.5" 14GA TUBE 2.25" X 2.25" 12GA TUBE/ SCALE: NTS




THICKNESS = 14GA

2" X 2" 14GA TUBE SCALE: NTS



THICKNESS = 14GA

2.5" X 1.5" 14GA CHANNEL SCALE: NTS

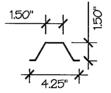

THICKNESS = 14GA / 18GA 4.25" X 1.5" X 14GA / 18GA

HAT CHANNEL SCALE: NTS




THICKNESS = 14GA

STRAIGHT BRACKET SCALE: NTS




THICKNESS = 14GA

ANGLE BRACKET SCALE: NTS

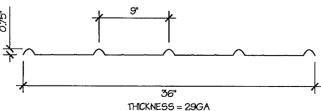


29 GA CORRUGATED SHEATHING

SCALE: NTS

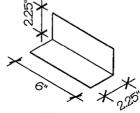

THICKNESS = 14GA

DB BRACKET, SCALE: NTS

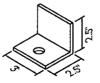

OPTION A L21/2" X 21/2" X 3/4"

OPTION B 12 1/2" X 2" X 3/4"

BASE ANGLE SCALE: NTS

SLV





ASA ENGINEERING COME * STRECTERAL

DRAWING IMPORMATION

LOCATED 20' Wide

PROJEION: STATE OF MICHIGAN

SHEET Gring. 033-24-0434 3111.6

SCHEDULES &

MEMBER SECTIONS


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CHECKÉ

OBY: OAA DATE: 1/25/24


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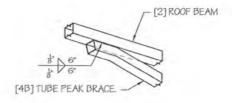
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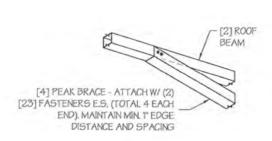
DATE PENDLY, MAR 24 2026

SICHO: 萨密图 25 2026



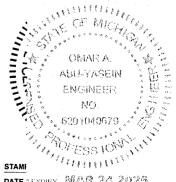



A. PEAK BRACE TUBE

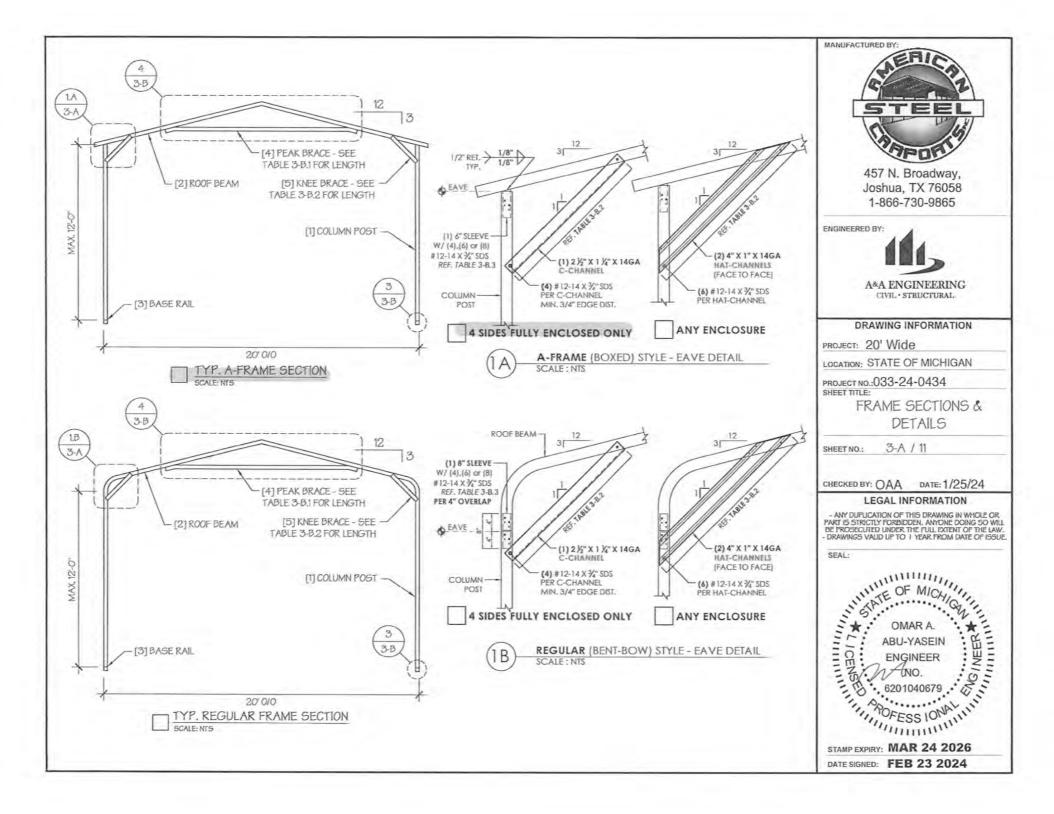

B. PEAK BRACE CHANNEL

PEAK BRACE CONNECTION DETAILS 2

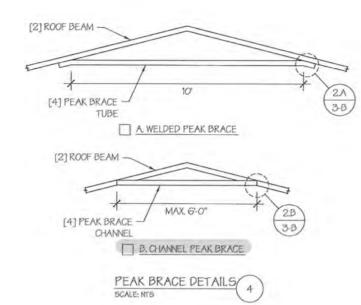

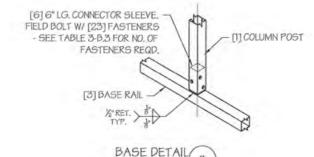

SCALE: NTS

TABLE 3-B.1: PEAK BRACE SCHEDULE

| GROUND SNOW / ROOF | WIND SPEED | | | |
|--------------------|-------------|-------------|--|--|
| LIVE LOAD (PSF) | □105 TO 130 | □140 TO 180 | | |
| D 30/20 | 6' | 10' | | |
| □ 35/25T0 90/61 | 10' | 10" | | |

TABLE 3-B.2: KNEE BRACE SCHEDULE

| EAVE HEIGHT | KNEE BRACE LENGTH |
|-------------|-------------------|
| DUP TO 8' | 24" |
| □ 9'TO12' | 36" |

TABLE 3-B.3 FASTENER SCHEDULE

| WIND SPEED (MPH) | NO. OF FASTENERS |
|------------------|------------------|
| □ 105 TO 125 | 4 |
| □ 130 TO 155 | 6 |
| □160 TO 180 | В |

NOTE: COLUMN POST MAY BE ADJUSTED ±1" FOR LEVELING.

MANUFACTURER IS NOT RESPONSIBLE FOR LEVELING OF GROUND

AND/OR CONCRETE SURFACE PROVIDED BY OTHERS.



TABLE 4: FRAME SPACING CHART / SCHEDULE

| GROUND SNOW / | | | ■ ENCLO | SED BUIL | DINGS | | | ■ OPEN BUILDINGS | | | | | | | |
|-------------------------------------|-------|------------------|---------|----------|-------|-------|-------|------------------|------------------|-------|-------|-------|-------|-------|--|
| ROOF LIVE | | WIND SPEED (MPH) | | | | | | | WIND SPEED (MPH) | | | | | | |
| LOAD (PSF) | □105 | □115 | □130 | □140 | □155 | □165 | □180 | □105 | □ 115 | □130 | □140 | ☐155 | □165 | □180 | |
| □30/20 | 60 | 60 | 54/60 | 54 | 42 | 36 | 36 | 60 | 54/60 | 48/60 | 42/54 | 36/42 | 36 | 36 | |
| □ 40 / 27 □ 50 / 34 □ 60 / 41 | 48/60 | 48/60 | 42/60 | 42/54 | 42 | 36 | 36 | 48 | 48 | 42/48 | 42/48 | 36/42 | 36 | 36 | |
| □50/34 | 40/48 | 40/48 | 40/48 | 40/48 | 40/42 | 36 | 36 | 40/42 | 40/42 | 40/42 | 40/42 | 36/42 | .36 | 36 | |
| 60/41 | 36/42 | 36/42 | 36/42 | 36/42 | 36/42 | 36 | 36 | 36 | 36 | 36 | 36 | 36 | 36 | 36 | |
| □70/47 □80/54 | 32/36 | 32/36 | 32/36 | 32/36 | 32/36 | 32/36 | 30 | 30 | 30 | 30 | 30 | 30 | 30 | 30 | |
| □80/54 | 30 | 30 | 30 | 30 | 30 | 30 | 30 | 24 | 24 | 24 | 24 | 24 | 24 | 24 | |
| 90/61 | 24 | 24 | 24 | 24 | 24 | 24 | 24 | 18 | 18 | 18 | 18 | 18 | 18 | 18 | |
| □30/20 | 60 | 60 | 54/60 | 54 | 48 | 42/48 | 42 | 60 | 54/60 | 48/60 | 42/54 | 36/48 | 36/48 | 36/42 | |
| □ 40 / 27 □ 50 / 34 | 48/60 | 48/60 | 42/60 | 42/54 | 42/48 | 42/48 | 42 | 48/54 | 48/54 | 42/54 | 42/54 | 36/48 | 36/48 | 36/42 | |
| 50/34 | 40/48 | 40/48 | 40/48 | 40/48 | 40/48 | 40/48 | 40/42 | 40/42 | 40/42 | 40/42 | 40/42 | 36/42 | 36/42 | 36/42 | |
| 060/41 | 36/42 | 36/42 | 36/42 | 36/42 | 36/42 | 36/42 | 36/42 | 36 | 36 | 36 | 36 | 36 | 36 | 36 | |
| 0 070/47 | 32/36 | 32/36 | 32/36 | 32/36 | 32/36 | 32/36 | 32/36 | 30 | 30 | 30 | 30 | 30 | 30 | 30 | |
| □ 70 / 47 □ 80 / 54 | 30 | 30 | 30 | 30 | 30 | 30 | 30 | 30 | 30 | 30 | 30 | 30 | 30 | 30 | |
| 90/61 | 24 | 24 | 24 | 24 | 24 | -24 | 24 | 24 | 24 | 24 | 24 | 24 | 24 | 24 | |
| □30/20 | 60 | 60 | 54/60 | 54 | 48 | 42/48 | 42 | 60 | 54/60 | 48/60 | 42/54 | 36/48 | 36/48 | 36/42 | |
| □ 40/27 | 48/60 | 48/60 | 42/60 | 42/54 | 42/48 | 42/48 | 42 | 48/60 | 48/60 | 42/60 | 42/54 | 36/48 | 36/48 | 36/42 | |
| □50/34 | 40/48 | 40/48 | 40/48 | 40/48 | 40/48 | 40/48 | 40/42 | 40/48 | 40/48 | 40/48 | 40/48 | 36/48 | 36/48 | 36/42 | |
| □ 50 / 34 □ 60 / 41 | 36/42 | 36/42 | 36/42 | 36/42 | 36/42 | 36/42 | 36/42 | 36/42 | 36/42 | 36/42 | 36/42 | 36/42 | 36/42 | 36/42 | |
| □70/47 | 32/36 | 32/36 | 32/36 | 32/36 | 32/36 | 32/36 | 32/36 | 32/36 | 32/36 | 32/36 | 32/36 | 32/36 | 32/36 | 32/36 | |
| □70/47 □80/54 | 30 | 30 | 30 | 30 | 30 | 30 | 30 | 30 | 30 | 30 | 30 | 30 | 30 | 30 | |
| □ 90 / 61 | 24 | 24 | 24 | 24 | 24 | 24 | 24 | 24 | 24 | 24 | 24 | 24 | 24 | 24 | |


- FRAME SPACINGS ARE IN UNITS OF INCHES (IN).
- WHERE TWO VALUES ARE SHOWN, THE HIGHER VALUE CAN ONLY BE USED FOR VERTICAL ROOF SHEATHING
- 3. SNOW LOADS AND ROOF LIVE LOADS ARE IN POUNDS PER SQUARE FOOT (PSF). WIND SPEED IS 3 SEC. GUST IN MILES PER HOUR (MPH).
- 4. FOR VALUES THAT LIE BETWEEN TWO CELLS, THE HIGHER (MORE STRINGENT) VALUE HAS TO BE USED. INTERPOLATION BETWEEN CELLS IS NOT ALLOWED.


ENCLOSURE CLASSIFICATION:

- ENCLOSED BUILDING = ALL 4 WALLS FULLY ENCLOSED WITH DOORS/WINDOWS = USE ENCLOSED BUILDING SPACING CHART.
- OPEN BUILDING = ALL 4 WALLS FULLY OPEN = USE OPEN BUILDING SPACING CHART.
- 3FT PARTIALLY ENCLOSED = BOTH END-WALLS FULLY OPEN, WITH BOTH SIDE-WALLS ONLY 3FT ENCLOSED = USE OPEN BUILDING SPACING CHART.
- 4. PARTIALLY ENCLOSED = BOTH END-WALLS FULLY OPEN, WITH BOTH SIDE-WALLS ENCLOSED MORE THAN 3FT = START WITH OPEN BUILDING SPACING CHART AND THEN REDUCE SPACING BY 6".
- 5. 3 SIDED ENCLOSED = ALL WALLS ARE ENCLOSED EXCEPT FOR 1 END-WALL = START WITH ENCLOSED BUILDING SPACING + THE OPEN END FRAME MUST HAVE EITHER A GABLED END OR HAVE DOUBLED WELDED LEGS & ROOF.
- 6. FOR ALL SHEATHING ENCLOSURES NOT LISTED ABOVE, REFER TO SHEET 5 FOR SPACING AND DESIGN REQUIREMENTS.

GENERAL NOTES:


- THE MAX. BUILDING LENGTH FOR ENCLOSED BUILDINGS IS 50'-0". THIS CAN BE INCREASED BY ADDING A DOUBLE FRAME AT THE CENTER TO BREAK THE LENGTH OF THE BUILDING.
- 2. BUILDINGS WITH PARTIALLY ENCLOSED END WALLS NEED TO HAVE SIDE WALL BRACING TO SUPPORT THE PARTIALLY ENCLOSED END WALL. (SEE FIGURE A ON SHEET 5).
- 3. ALL BUILDINGS WITH AN OPEN END WALL MUST HAVE A 10'-O" TUBE PEAK BRACE.

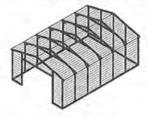

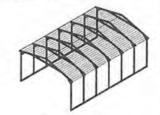

TYP. ENCLOSED BUILDING

TYP. OPEN BUILDING

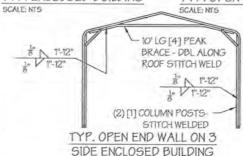

SCALE: NTS



457 N. Broadway Joshua, TX 76058 1-866-730-9865

ENGINEERED BY:



A&A ENGINEERING CIVIL + STRUCTURAL

DRAWING INFORMATION

PROJECT: 20' Wide

LOCATION: STATE OF MICHIGAN

PROJECT NO.: 033-24-0434

SHEET TITLE:

SPACING SCHEDULES & ENCLOSURE NOTES

4/11

SHEET NO .:

CHECKED BY: OAA DATE: 1/25/24

LEGAL INFORMATION

ANY DUPLICATION OF THIS DRAWING IN WHOLE OR PART IS STRICTLY FORBIDDEN. ANYONE DOING SO WILL BE PROSECUTED UNDER THE FULL EXTENT OF THE LAW. DRAWINGS VALID UP TO 1 YEAR FROM DATE OF ISSUE

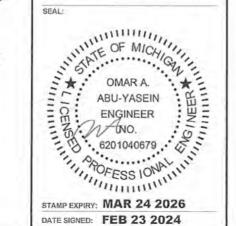


TABLE 5.1: PURLIN SPACING SCHEDULE

| | GROUND SNOW / | | 14GA | . HAT | CHA | NNEL | PURI | IN | | 18GA | . HAT | CHA | NNEL | PURI | IN |
|----------------|------------------|-----|------|--------|------|------|------|-----|-----|------|--------|------|------|------|-----|
| | ROOF LIVE | 9 | V | VIND S | PEED | (MP) | i) | | | y | VIND S | PEED | (MP) | 1) | |
| | LOAD (PSF) | 105 | 115 | 130 | 140 | 155 | 165 | 180 | 105 | 115 | 130 | 140 | 155 | 165 | 180 |
| .80 | 0.30/20 | 54 | 48 | 42 | 36 | 30 | 24 | 24 | 36 | 30 | 24 | 18 | 18 | 12 | 12 |
| CINO | □ 40 / 27 | 42 | 42 | 42 | 36 | 30 | 24 | 24 | 30 | 30 | 24 | 18 | 18 | 12 | 12 |
| < . | □50/34 | 40 | 40 | 40 | 36 | 30 | 24 | 24 | 24 | 24 | 24 | 18 | 18 | 12 | 12 |
| 5.5 | D 60 / 41 | 36 | 36 | 36 | 36 | 30 | 24 | 24 | 18 | 18 | 18 | 18 | 18 | 12 | 12 |
| FRAME SI | 0.70/47 | 32 | 32 | 32 | 32 | 30 | 24 | 24 | 18 | 18 | 18 | 18 | 18 | 12 | 12 |
| \$ | □ 80 / 54 | 30 | 30 | 30 | 30 | 30 | 24 | 24 | 18 | 18 | 18 | 18 | 18 | 12 | 12 |
| IL. | □ 90 / 61 | 24 | 24 | 24 | 24 | 24 | 24 | 24 | 12. | 12 | 12 | 12 | 12 | 12 | 12 |
| Æ | □30/20 | 54 | 48 | 42 | 42 | 36 | 30 | 30 | 48 | 36 | 30 | 24 | 18 | 18 | 12 |
| CING | □ 40/27 | 42 | 42 | 42 | 42 | 36 | 30 | 30 | 42 | 36 | 30 | 24 | 18 | 18 | 12 |
| 6 | □ 50 / 34 | 40 | 40 | 40 | 40 | 36 | 30 | 30 | 30 | 30 | 30 | 24 | 18 | 18 | 12 |
| E SP/ 4'-6" | □ 60 / 41 | 36 | 36 | 36 | 36 | 36 | 30 | 30 | 30 | 30 | 30 | 24 | 18 | 18 | 12 |
| | □ 70 / 47 | 32 | 32 | 32 | 32 | 32 | 30 | 30 | 24 | 24 | 24 | 24 | 18 | 18 | 12 |
| FRAM | □80/54 | 32 | 32 | 32 | 32 | 32 | 30 | 30 | 18 | 18 | 18 | 18 | 18 | 18 | 12 |
| III. | D 90/61 | 30 | 30 | 30 | 30 | 30 | 30 | 30 | 18 | 18 | 18 | 18 | 18 | 18 | 12 |
| .*: | D 30 / 20 | 54 | 48 | 42 | 42 | 36 | 36 | 30 | 54 | 48 | 36 | 30 | 24 | 24 | 18 |
| 2 | □ 40 / 27 | 42 | 42 | 42 | 42 | 36 | 36 | 30 | 42 | 42 | 36 | 30 | 24 | 24 | 18 |
| SPACING: | □ 50 / 34 | 40 | 40 | 40 | 40 | 36 | 36 | 30 | 40 | 40 | 36 | 30 | 24 | 24 | 18 |
| SP 0.4 | □ 60 / 41 | 36 | 36 | 36 | 36 | 36 | 36 | 30 | 36 | 36 | 36 | 30 | 24 | 24 | 18 |
| FRAME | □ 70 / 47 | 32 | 32 | 32 | 32. | 32 | 32 | 30 | 30 | 30 | 30 | 30 | 24 | 24 | 18 |
| \$ | □ 80 / 54 | 32 | 32 | 32 | 32 | 32 | 32 | 30 | 24 | 24 | 24 | 24 | 24 | 24 | 18 |
| 11 | □ 90 / 61 | 30 | 30 | 30 | 30 | 30 | 30 | 30 | 24 | 24 | 24 | 24 | 24 | 24 | 18 |
| ak. | □ 30 / 20 | 54 | 48 | 42 | 42 | 36 | 36 | 30 | 54 | 48 | 42 | 42 | 36 | 30 | 30 |
| ACING: | □ 40 / 27 | 42 | 42 | 42 | 42 | 36 | 36 | 30 | 42 | 42 | 42 | 42 | 36 | 30 | 30 |
| × . | □ 50 / 34 | 40 | 40 | 40 | 40 | 36 | 36 | 30 | 40 | 40 | 40 | 40 | 36 | 30 | 30 |
| : SP/ | 0 60 / 41 | 36 | 36 | 36 | 36 | 36 | 36 | 30 | 36 | 36 | 36 | 36 | 36 | 30 | 30 |
| | □ 70 / 47 | 32 | 32 | 32 | 32 | 32 | 32 | 30 | 32 | 32 | 32 | 32 | 32 | 30 | 30 |
| FRAME | □ 80 / 54 | 32 | 32 | 32 | 32 | 32. | 32 | 30 | 32 | 32 | 32 | 32 | 32 | 30 | 30 |
| Ψ. | □ 90 / 61 | 30 | 30 | 30 | 30 | 30 | 30 | 30 | 30 | 30 | 30 | 30 | 30 | 30 | 30 |
| AS | □30/20 | 54 | 48 | 42 | 42 | 36 | 36 | 30 | 54 | 48 | 42 | 42 | 36 | 36 | 30 |
| CING: WER | □ 40 / 27 | 42 | 42 | 42 | 42 | 36 | 36 | 30 | 42 | 42 | 42 | 42 | 36 | 36 | 30 |
| K (0) | 1100104 | 40 | 40 | 40 | 40 | 36 | 36 | 30 | 40 | 40 | 40 | 40 | 36 | 36 | 30 |
| 80 87 27 | ID 60 / 41 | 36 | 36 | 36 | 36 | 36 | 36 | 30 | 36 | 36 | 36 | 36 | 36 | 36 | 30 |
| IIII | □ 70 / 47 | 32 | 32 | 32 | 32 | 32 | 32 | 30 | 32 | 32 | 32 | 32 | 32 | 32 | 30 |
| FRAM 3-0- | □ 80 / 54 | 32 | 32 | 32 | 32 | 32 | 32 | 30 | 32 | 32 | 32 | 32 | 32 | 32 | 30 |
| | D 90/61 | 30 | 30 | 30 | 30 | 30 | 30 | 30 | 30 | 30 | 30 | 30 | 30 | 30 | 30 |

NOTES:

- 1. PURLIN SPACING UNITS ARE IN INCHES.
- 2. FRAME SPACING NEEDS TO BE DETERMINED FROM TABLE 4.

IRREGULAR BUILDING NOTES:


- 1. FIGURES A, B, C & D ON THE RIGHT INDICATE EXAMPLES OF IRREGULAR BUILDINGS.
- FOR IRREGULAR BUILDINGS, FRAME SPACING MUST BE REDUCED BY 6" FROM OPEN BUILDING SPACING TABLE. SEE SHEET
 4 FOR OPEN BUILDING TABLE.
- SITE SPECIFICS MAY ALLOW FOR ALTERNATIVE SPACING.
- 4. IRREGULAR BUILDING & BUILDINGS W/ MORE THAN 2 SIDE OPENINGS MUST HAVE A 10' TUBE PEAK BRACE ON ALL FRAMES,

TABLE 5.2: GIRT SPACING SCHEDULE


| FRAME | WIND SPEED (MPH) | | | | | | | | | |
|------------------|------------------|-----|-----|-----|-----|-----|-----|--|--|--|
| SPACING | 105 | 115 | 130 | 140 | 155 | 165 | 180 | | | |
| D5-0* | 60 | 48 | 36 | 30 | 24 | 24 | 18 | | | |
| □4'-6" | 60 | 60 | 48 | 42 | 36 | 30 | 24 | | | |
| D 4'-0" | 60 | 60 | 54 | 54 | 42 | 36 | 30 | | | |
| D3-6° | 60 | 60 | 54 | 54 | 48 | 42 | 42 | | | |
| E12'-0' TO 3'-0" | 60 | 60 | 54 | 54 | 48 | 42 | 42 | | | |

NOTES:

- 1. GIRT SPACING UNITS ARE IN INCHES.
- THIS SCHEDULE IS TO BE USED FOR BOTH 14GA AND 18 GA PURLINS.
- FRAME SPACING NEEDS TO BE DETERMINED FROM TABLE 4.

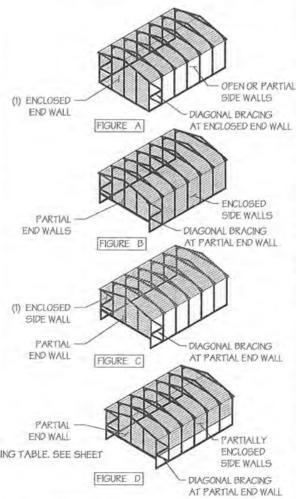



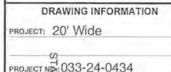

SPECING SCHEDULES

5/11

SHEET NO.

CHECKED BY: OAA DATE: 1/25/24


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STAMP EXPIRY: MAR 242026





457 N. Broadway, Joshua, TX 76058 1-866-730-9865

ENGINEERED BY:

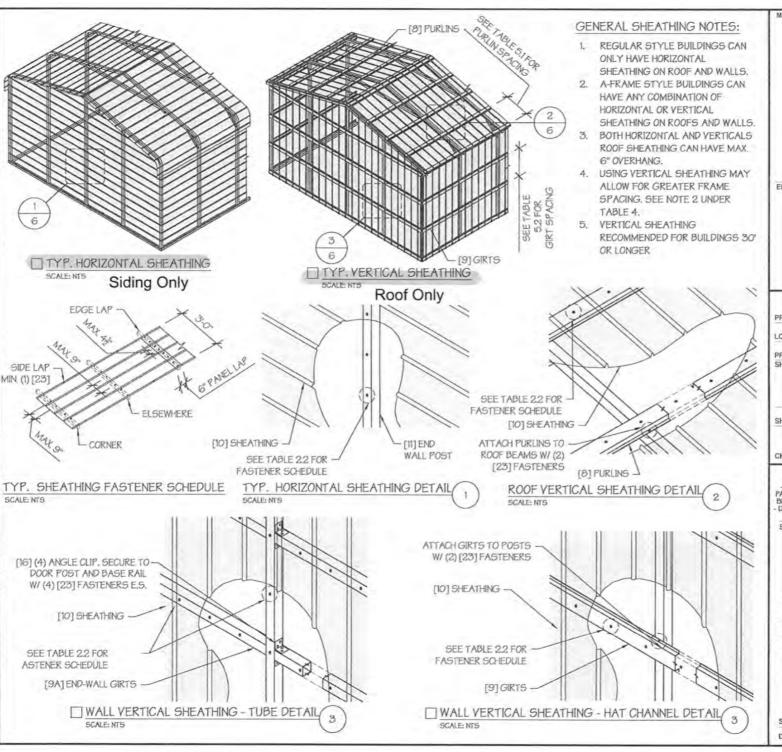

A&A ENGINEERING CIVIL . STRUCTURAL

DRAWING INFORMATION

PROJECT: 20' Wide

LOCATION: STATE OF MICHIGAN

PROJECT NO.:033-24-0434

SHEET TITLE:

SHEATHING OPTIONS & DETAILS

SHEET NO .:

6/11


CHECKED BY: OAA DATE: 1/25/24

LEGAL INFORMATION

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STAMP EXPIRY: MAR 24 2026



BETWEEN TWO FRAMES THAT HAS NO OVERHEAD DOOR OPENINGS. MIN. 1 CLEAR BAY MUST ALSO BE MAINTAINED FROM THE BUILDING CORNERS.

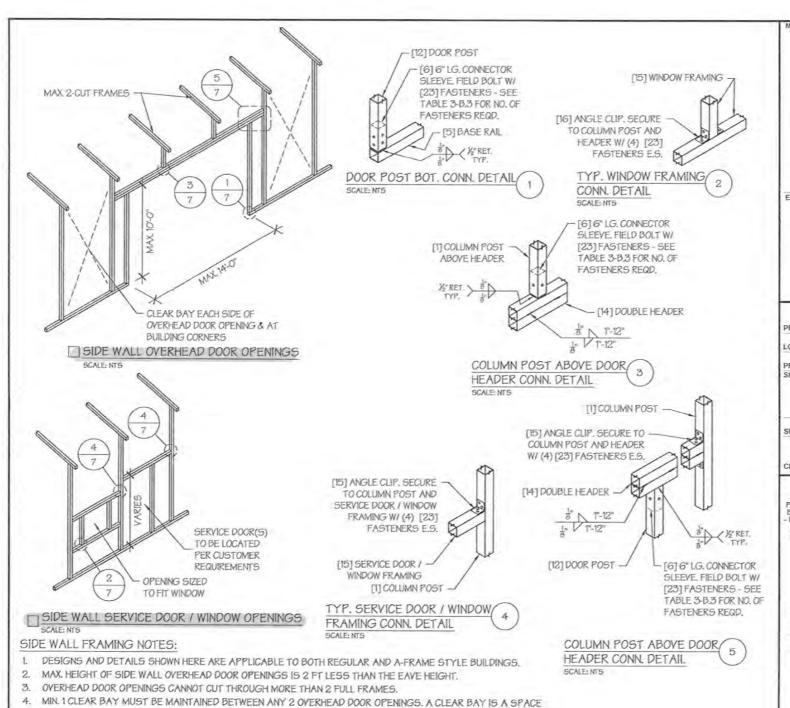
SERVICE DOORS AND WINDOWS CAN BE PLACED IN CLEAR BAYS OR ANY WHERE ELSE AS NEEDED.

457 N. Broadway, Joshua, TX 76058 1-866-730-9865 ENGINEERED BY A&A ENGINEERING CIVIL. STRUCTURAL DRAWING INFORMATION PROJECT: 20' Wide LOCATION: STATE OF MICHIGAN PROJECT NO.: 033-24-0434 SHEET TITLE: SIDE WALL FRAMING & OPENINGS 7 // 11 SHEET NO .: CHECKED BY: OAA DATE: 1/25/24 LEGAL INFORMATION ANY DUPLICATION OF THIS DRAWING IN WHOLE OR PART IS STRUCTLY FORBIDDEN. ANYONE DOING SO WILL BE PROSECUTED UNDER THE FULL EXTENT OF THE LAW. DRAWINGS VALID UP TO 1 YEAR FROM DATE OF ISSUE. OMAR A.

ABU-YASEIN
ENGINEER
INO.
6201040679

OFESS 10NA

STAMP EXPIRY: MAR 24 2026

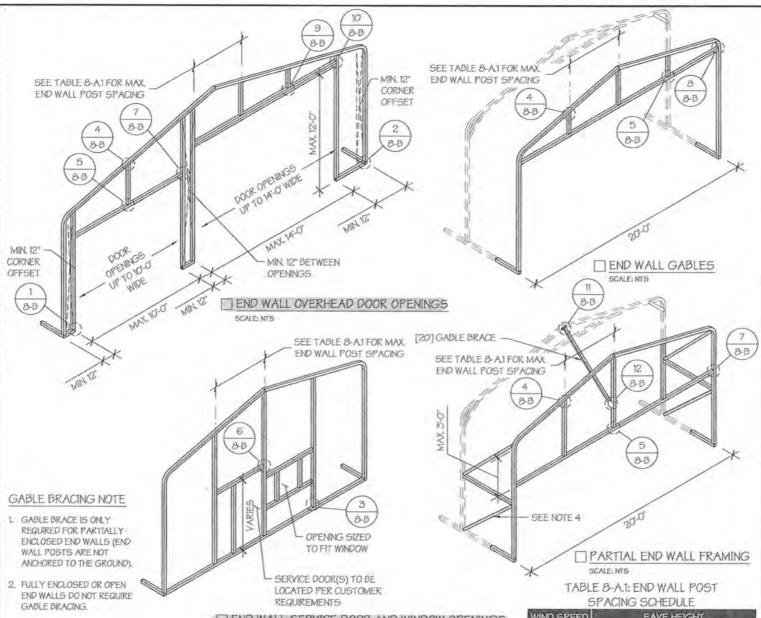

END WALL SERVICE DOOR AND WINDOW OPENINGS SCALE: NTS

END WALL FRAMING NOTES:

- DESIGNS AND DETAILS SHOWN HERE ARE APPLICABLE TO BOTH REGULAR AND A-FRAME STYLE BUILDINGS.
- 2. MIN. 12" CLEARANCE MUST BE MAINTAINED BETWEEN ANY TWO OPENINGS (OVERHEAD DOOR OR SERVICE DOOR) AND FROM CORNERS.
- 3. SERVICE DOORS AND WINDOWS CAN BE PLACED AS NEEDED.
- 4. DIAGONAL BRACES NEED TO BE ADDED FOR PARTIAL END WALL ENCLOSURES. SEE SHEET 9 FOR DIAGONAL BRACE CONNECTION DETAILS.

| WIND SPEED | EAVE HEIGHT | | | | | | | | |
|-------------|-------------|----------|-------------|--|--|--|--|--|--|
| (MPH) | UP TO 7 | ■ 8'T09' | ■10' TO 12' | | | | | | |
| □ 105 | 5 | 5' | 5 | | | | | | |
| □ 115 | 5 | 5' | 4.5 | | | | | | |
| □ 130 | 4.5 | 4.5 | 4' | | | | | | |
| □ 140 | 4.5 | 4.5 | 3' | | | | | | |
| □ 155 | 4 | 4' | 2.5 | | | | | | |
| □ 165 - 180 | 3.5 | 3' | 2 | | | | | | |



1-866-730-9865 ENGINEERED BY:

> A&A ENGINEERING CIVIL . STRUCTURAL

DRAWING INFORMATION

PROJECT: 20' Wide

LOCATION: STATE OF MICHIGAN

PROJECT NO: 033-24-0434 SHEET TITLE:

END WALL FRAMING

8-A / 11 SHEET NO .:


CHECKED BY: OAA DATE: 1/25/24

LEGAL INFORMATION

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STAMP EXPIRY: MAR 24 2026



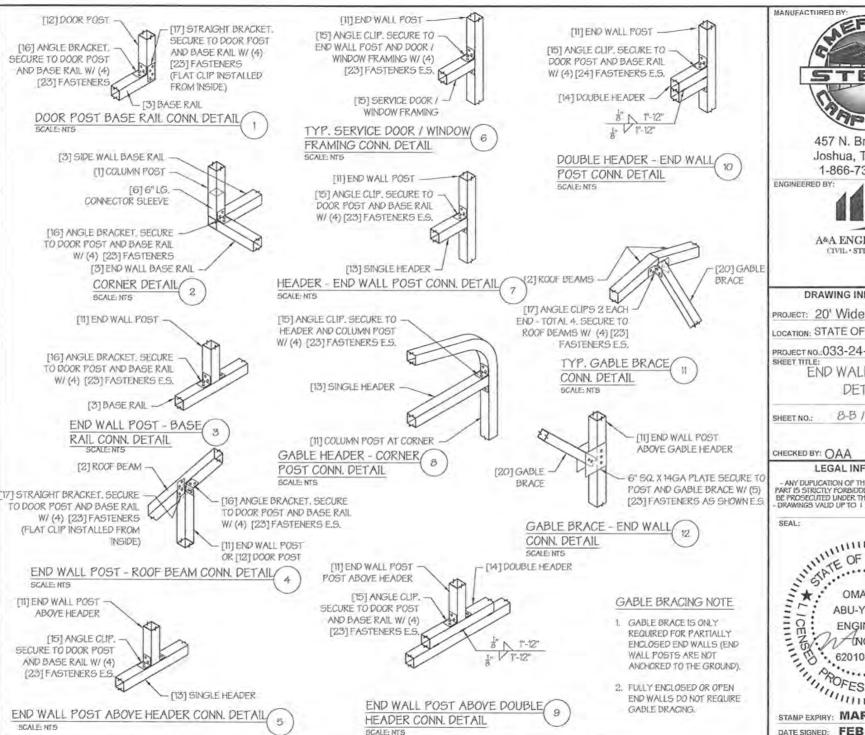

A&A ENGINEERING CIVIL · STRUCTURAL

DRAWING INFORMATION

PROJECT: 20' Wide

LOCATION: STATE OF MICHIGAN

PROJECT NO.: 033-24-0434 SHEET TITLE:

END WALL FRAMING DETAILS

8-B / 11 SHEET NO .:


LEGAL INFORMATION

DATE: 1/25/24

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STAMP EXPIRY: MAR 24 2026



OPTION 2: ROCK / ASPHALT ANCHORS

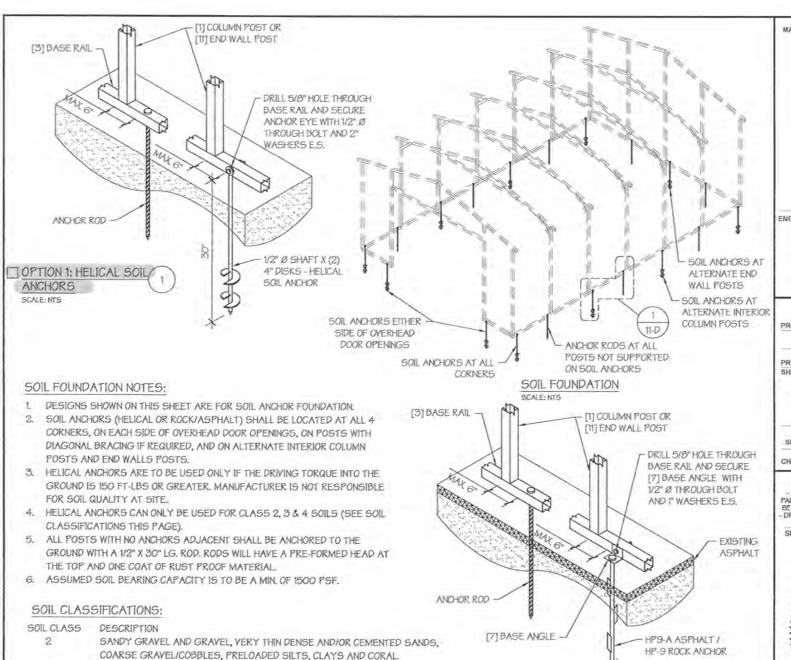SAND, SILTY SAND, CLAYEY SAND, SILTY GRAVEL, MEDIUM DENSE COARSE

SANDS, SANDY GRAVEL, VERY STIFF SILT AND SANDY CLAYS. LOOSE TO MEDIUM DENSE SANDS, FIRM TO STIFF CLAYS AND SILTS AND

3

ALLUVIAL FILLS

"FROM HUD "MODEL MANUFACTURED HOME INSTALLATION STANDARDS"

MANUFACTURED BY:

457 N. Broadway, Joshua, TX 76058 1-866-730-9865

ENGINEERED BY:



A&A ENGINEERING CIVIL . STRUCTURAL

DRAWING INFORMATION

PROJECT: 20' Wide

LOCATION: STATE OF MICHIGAN

PROJECT NO.: 033-24-0434

SHEET TITLE:


FOUNDATION OPTION 4: SOIL ANCHORS


SHEET NO .: 11-D / 11

DATE: 1/25/24 CHECKED BY: OAA

LEGAL INFORMATION

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HERBST ESTATES

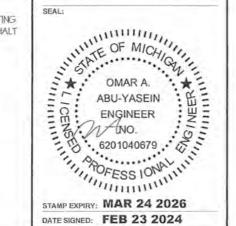A SUBDIVISION OF PART OF THE NW 1/4 AND SW 1/4 OF SEC. 13, T. 2 N., R. 5 E., GENOA TOWNSHIP, LIVINGSTON COUNTY, MICHIGAN.
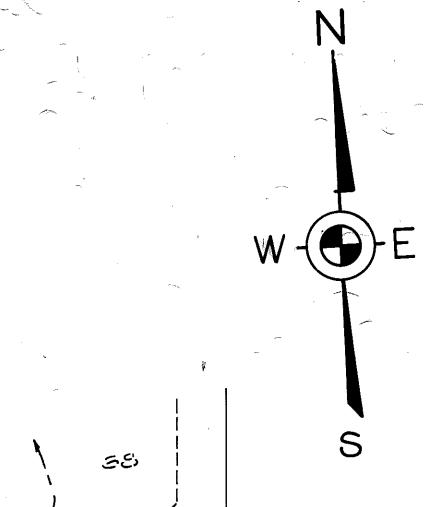
> 0 20 40 60 80 100 150 200 300 SCALE: 1"= 100'


PLAT LEGENS

ALL CURVILINEAR DIMENSIONS ARE SHOWN ALONG THE ARC.

THE SYMBOL "O" INDICATES A CONCRETE

ALL LOT MARKERS ARE 1/2" IEON RODE, 15" LONG.

ALL BEARINGS ARE RELATED TO THE BEARING SHOWN FOR THE E'LY LINE OF GRAND BEACH NO. 3 SUB'N. (LIBER 16, PAGES 9\$10, LIVINGSTON COUNTY RECORDS.)

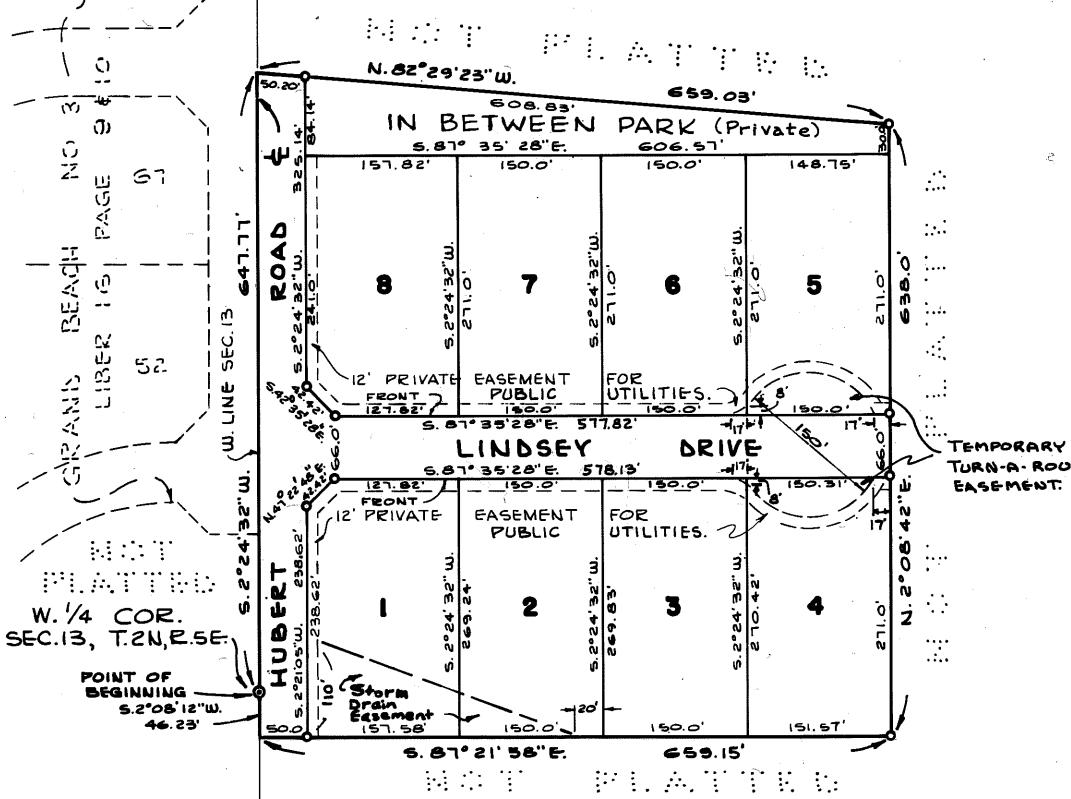

CERTIFIED TRUE COPY OF RECORDED PLAT


C. P. SA

STATE TREASURER

Bedard & Domas

Bedard E. Lomas, Plot Braminer


1:te March 24, 1979

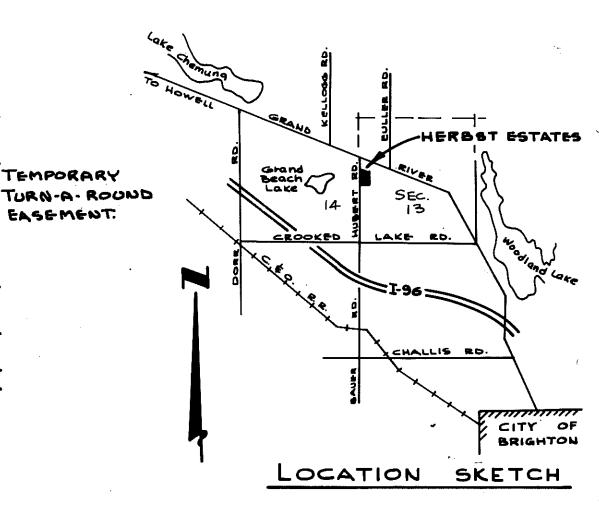

HERBERT L. MUNZEL

REG. PZOF. ENGINEER #9244

222 WEST GRAND RIVER BRIGHTON, MICHIGAN 45116

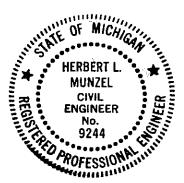

| Grantor | | | | Sale Price | Sale Date | Inst. Type | Terms of Sale | Libe: | | rified | Prcnt. Trans. |
|-------------------------|--|-----|-----------------------------|---------------|--------------|---------------|--------------------|----------------|----------------------|------------|------------------|
| MILESKI | | | | | 07/23/1998 | | 03-ARM'S LENGTH | | | ER/SELLER | 100.0 |
| HILESICI | DEBION | | | 137,300 | 07/23/1330 | WD | US ANT S LENGTH | 2331 | 0031 1003 | EK/ SEDDEK | 100.0 |
| | | | | | | | | | | | |
| | | | | | | | | | | | |
| | | | | | | | | | | | |
| Property Address | ' | Cla | ss: RESIDENT | IAL-IMPE | OV Zoning: I | DR Buil | lding Permit(s) | Da | ite Number | S | tatus |
| 7022 LINDSEY DR | | Sch | ool: HOWELL | PUBLIC S | CHOOLS | | | | | | |
| | | P.R | .E. 100% 07/ | 23/1998 | | | | | | | |
| Owner's Name/Address | | | #: V24-25 | | | | | | | | |
| DELYON, GERARD & JO ANI | J | | | | | | | | | | |
| 7022 LINDSEY DR | | | 2025 Est TCV | | | | | | | | |
| BRIGHTON MI 48114-9439 | | X | Improved | Vacant | Land Va | lue Estima | ates for Land Tabl | e 4004.4004 GI | RAND BEACH | | |
| | | | Public | | | | | actors * | | | |
| | | : | Improvements | | | | ontage Depth Fro | | | on | Value |
| Tax Description | | | Dirt Road | | | | SITE VALUE | 60000 | 100 tal Est. Land | 77-7 | 60,000 |
| SEC 13 T2N R5E HERBST I | ZSTATES SIIR I.OT 1 | | Gravel Road | | 13 / A | ctual Fron | nt Feet, 0.97 Tota | ii Acres To | .ai ESt. Land | value = | 60,000 |
| Comments/Influences | BOIMING BOD, NOT 1 | | Paved Road Storm Sewer | | | | | | | | |
| | | | Storm Sewer Sidewalk | | | | | | | | |
| | | | Water | | | | | | | | |
| | | | Sewer | | | | | | | | |
| | | | Electric | | | | | | | | |
| | | | Gas | | | | | | | | |
| | | | Curb | | | | | | | | |
| | | | Street Light | | | | | | | | |
| | | | Standard Uti Underground | | | | | | | | |
| | | | | | | | | | | | |
| | | | Topography o | f | | | | | | | |
| | | | Site | | | | | | | | |
| | | | Level | | | | | | | | |
| | | | Rolling Low | | | | | | | | |
| | WE CHE | 94 | High | | | | | | | | |
| Visit is | | | Landscaped | | | | | | | | |
| 200 | | | Swamp | | | | | | | | |
| A THE PROPERTY OF | A. A | | Wooded | | | | | | | | |
| | | | Pond | | | | | | | | |
| | | | Waterfront | | | | | | | | |
| | | | Ravine Wetland | | | | | | | | |
| | | | Wettand Flood Plain | | Year | Land | d Building | Assessed | Board of | Tribunal | / Taxable |
| | TO STATE OF THE ST | | REFUSE | | | Value | | Value | Review | Other | |
| 1 | THE REAL PROPERTY. | Who | | What | 2025 | 30,000 | 0 131,400 | 161,400 | | | 102,4300 |
| 4711-13-101-001 | D3/4D/2D2 | 8 | 03/10/2021 | | | 27,500 | · | 152,600 | | | 102,4300 |
| | 7711-13-101-001 03/10/2021 The Equalizer. Copyright (c) 1999 - 2009. | | 05/26/2011 | DATA ENT | | | | | | | |
| Licensed To: Township | | | ,, | | | 27,500 | | 142,000 | | | 97,5530 |
| Livingston, Michigan | | | | | 2022 | 27,500 | 0 111,100 | 138,600 | | | 92,9080 |

Parcel Number: 4711-13-101-001 Jurisdiction: GENOA CHARTER TOWNSHIP County: LIVINGSTON

Printed on

08/09/2024

^{***} Information herein deemed reliable but not guaranteed***

| Building Type | (3) Roof (cont.) | (11) Heating/Cooling | (15) Built-ins | (15) Fireplaces | (16) Porches/De | ecks (17) Garage |
|--|---|---|---|--|-------------------------------------|---|
| X Single Family Mobile Home Town Home Duplex A-Frame X Wood Frame Building Style: BC | Eavestrough Insulation 0 Front Overhang 0 Other Overhang (4) Interior Drywall Plaster Paneled Wood T&G Trim & Decoration | X Gas Wood Coal Elec. Wood Coal Steam Forced Air w/o Ducts Forced Hot Water Electric Baseboard Elec. Ceil. Radiant Radiant (in-floor) Electric Wall Heat | Appliance Allow. Cook Top Dishwasher Garbage Disposal Bath Heater Vent Fan Hot Tub Unvented Hood Vented Hood Intercom | Interior 1 Story Interior 2 Story 2nd/Same Stack Two Sided Exterior 1 Story Exterior 2 Story 1 Prefab 1 Story Prefab 2 Story Heat Circulator Raised Hearth | Area Type 88 CCP (1 Sto | Year Built: Car Capacity: Class: BC Exterior: Siding Brick Ven.: 0 Stone Ven.: 0 Common Wall: 1 Wall Foundation: 42 Inch Finished ?: Auto. Doors: 0 |
| Yr Built Remodeled 1979 0 Condition: Good | Ex X Ord Min Size of Closets Lg X Ord Small Doors: Solid X H.C. | Space Heater Wall/Floor Furnace Forced Heat & Cool Heat Pump No Heating/Cooling Central Air Wood Furnace | Jacuzzi Tub Jacuzzi repl.Tub Oven Microwave Standard Range Self Clean Range | Wood Stove Direct-Vented Gas Class: BC Effec. Age: 25 Floor Area: 1,568 Total Base New: 307 | ,076 E.C | |
| Basement 1st Floor 2nd Floor | (5) Floors Kitchen: Other: | (12) Electric 0 Amps Service | Trash Compactor Central Vacuum Security System | Total Depr Cost: 230 Estimated T.C.V: 262 | | Carport Area: |
| 4 Bedrooms (1) Exterior | Other: | No./Qual. of Fixtures Ex. X Ord. Min | (11) Heating System: | | | Cls BC Blt 1979 |
| X Wood/Shingle Aluminum/Vinyl Brick Insulation (2) Windows | (6) Ceilings | No. of Elec. Outlets Many X Ave. Few | Phy/Ab.Phy/Func/Econ Building Areas Stories Exterio 1 Story Siding Bi-Level Siding | Basement Bi-Lev. 80% | 100/100/75 Size Co 528 552 | ost New Depr. Cost |
| Many Large X Avg. X Avg. Few Small | Basement: 528 S.F. Crawl: 0 S.F. Slab: 0 S.F. | 1 2 Fixture Bath Softener, Auto Softener, Manual | 1 Story Siding Other Additions/Adju | Overhang | | 248,621 186,462 |
| Wood Sash Metal Sash Vinyl Sash Double Hung | Height to Joists: 0.0 (8) Basement Conc. Block | Solar Water Heat No Plumbing Extra Toilet Extra Sink | 2 Fixture Bath Water/Sewer 1000 Gal Septic Water Well, 200 Fe | et | 1 1 1 | 4,740 3,555 5,836 4,377 12,132 9,099 |
| Horiz. Slide Casement Double Glass | Poured Conc. Stone Treated Wood | Separate Shower Ceramic Tile Floor Ceramic Tile Wains Ceramic Tub Alcove | Porches CCP (1 Story) Garages Class: BC Exterior: | Siding Foundation: 42 | 88 Inch (Unfinished | 3,323 2,492 |
| Patio Doors Storms & Screens (3) Roof | Concrete Floor (9) Basement Finish Recreation SF | Vent Fan (14) Water/Sewer Public Water | Base Cost Common Wall: 1 Wal Fireplaces | | 440 | 27,628 20,721 -3,227 -2,420 |
| X Gable Gambrel Hip Mansard Flat Shed | Living SF Walkout Doors (B) No Floor SF Walkout Doors (A) | Public Sewer 1 Water Well 1 1000 Gal Septic | Prefab 1 Story Lump Sum Items | | 1 Totals: | 3,796 2,847 4,227 3,170 307,076 230,303 |
| X Asphalt Shingle Chimney: Brick | (10) Floor Support Joists: Unsupported Len: Cntr.Sup: | 2000 Gal Septic Lump Sum Items: 4,227 | Notes: ECF | (4004 GRAND BEACH/HERI | | |

^{***} Information herein deemed reliable but not guaranteed***

GENOA CHARTER TOWNSHIP ZONING BOARD OF APPEALS July 23, 2024 - 6:30 PM

MINUTES

<u>Call to Order</u>: Chairperson McCreary called the regular meeting of the <u>Zoning</u> Board of Appeals to order at 6:30 pm. The members and staff of the Zoning Board of Appeals were present as follows: Bill Rockwell, Craig Fons, Marianne McCreary, Michele Kreutzberg, and Amy Ruthig, Planning Director.

Pledge of Allegiance: The Pledge of Allegiance was recited.

<u>Introduction</u>: The members of the Board and staff introduced themselves.

Conflict of Interest: None

Approval of the Agenda:

Moved by Board Member Kreutzberg, supported by Board Member Rockwell, to approve the agenda as presented. **The motion carried unanimously.**

Call to the Public:

The call to the public was made at 6:32 pm with no response.

Chairperson McCreary reviewed the criteria necessary for a variance to be approved.

OLD BUSINESS:

1. 24-12... (APPLICANT REQUESTS TO BE POSTPONED) A request by Michael Brown, 4655 Sweet Road, for a side yard setback variance and any other variance deemed necessary by the Zoning Board of Appeals, to allow solar panels to remain.

Moved by Board Member Rockwell, supported by Board Member Kreutzberg, to postpone Case #24-12 until the August 20, 2024 ZBA meeting. **The motion carried unanimously**

2. 24-20...A request by James Frederick, 1632 High Haven, for front yard setback variance and any other variance deemed necessary by the Zoning Board of Appeals, to construct a new home.

Mr. James Frederick spoke with Livingston County and learned that he must be 5 feet from the septic field and 10 feet from the septic tank. He is proposing to relocate the home and is now

asking for a variance of 12 feet. He did research purchasing a different home; however, he was not able to find one that he could afford that would fit on this site.

Mr. Frederick showed a sketch of the site and a floor plan of the home.

Chairperson McCreary stated that the need for the variance is self-created because the property is there and the septic field is there and the applicant is trying to fit his existing home here. She appreciates his research to relocate the home and lessen the variance amount requested. Mr. Frederick stated that the property is small. He is 23 feet behind the end of the fence line on the property.

Board Member Kreutzberg questioned if the size of the property has been verified. The plat says 125 feet; however, Mr. Frederick's plan shows it is 128 feet. Ms. Ruthig confirmed that it is 125 feet.

Board Member Rockwell agrees that the need for the variance is self-created.

The call to the public was made at 6:46 pm with no response.

Moved by Board Member Kreutzberg, supported by Board Member Rockwell, to deny Case #24-20, submitted by James Frederick of 1632 High Haven, based on the following findings of fact:

- Strict compliance with the setbacks would not unreasonably prevent/restrict intended use of the property or cause it to be unbuildable. The need for the variance is self-created.
- This variance will not provide substantial justice, is not the least necessary and would make the property inconsistent with other properties and homes in the area.
- There are no extraordinary circumstances as property will comfortably fit a smaller home.
- Granting this variance would not impair adequate light or air to adjacent properties, would not increase congestion or increase danger or fire or threaten public safety or welfare.
- The variance would have little or no impact on the appropriate development, continued use or value of adjacent properties and surrounding neighborhood.

The motion carried unanimously.

NEW BUSINESS:

3. 24-21...A request by Christopher Malysz, 1330 Clark Lake Road, appealing the decision regarding interpretation of conditions for approval of Zoning Board of Appeals Case 14-21.

Chairperson McCreary reviewed the reason for the applicant's appeal, which is the requirement that an as-built drawing be signed and sealed by a licensed engineer.

Mr. Malysz stated he is appealing the interpretation of the condition. He requested additional time to review his paperwork to respond.

The Board agreed to move onto Agenda Item #4.

He returned before the Board at 7:13 pm.

He reviewed the conditions of the approval from the 2014 minutes. He is contesting that the current Zoning Administrator is requiring him to present signed engineered drawings. This is not the same as as-built drawings. They are requiring something that is above and beyond the condition of the ZBA approval.

Chairperson McCreary was on the ZBA in 2014 and she recalls this case and the requirement for plans to be submitted when the project was complete. She reviewed documents provided in this evening's packet as well as a report from the township's planner dated July 16, 2024, which confirms that as builts are signed by a licensed engineer. Mr. Malysz stated it is a hardship for him to hire an engineer to review what was built. This will cost approximately \$10,000. He questioned how many applicants are required to provide engineered as builts. Chairperson McCreary stated it was required for Mr. Malysz because there were concerns with how the work was being done. The Board wanted to ensure that what was approved is what was built.

Board Member Kreutzberg asked that, since the applicant is a licensed builder, can he draw up the plans and have an engineer review and sign them. Ms. Ruthig stated that would be a decision that would need to be made by the Board.

Mr. Fons stated that as builts were required to be submitted after each of his projects. That information went from him to the engineer on the job, he or she reviewed it and made any necessary changes, signed and stamped them and submitted them as the final record of the project. There must be a person of authority who reviews and approves the final plans.

Ms. Ruthig stated that staff has required as builts be provided numerous times and they require an engineer's certification.

There was a discussion regarding the motions from previous ZBA meetings regarding Mr. Malysz's cases and a letter from William Goodreau, the applicant's engineer at the time the variance was granted.

The call to the public was made at 7:44 pm.

Mr. Ken Frasheski of 1348 Clark Lake Road is pleased to hear that a certified civil engineer approves all projects. When someone lives on a lake, they are a steward of the environment and have to protect it. Mr. Malysz's earth moving has caused erosion on his property. He explained and showed a photograph of the erosion issues on his property. There was never an erosion barrier put in place to protect his property. He wants the engineered plans to be submitted.

The call to the public was closed at 7:51 pm.

Board Rockwell asked for confirmation that the township requires as builts signed by an engineer. Ms. Ruthig stated that is correct.

Mr. Malysz asked for clarification of what is being required. Can he submit a set of drawings confirming the plans that were submitted is what was built? The Board agreed, stating the plans from 2011 that were signed and sealed by William Goodreau are what needs to be submitted as the as-builts which are required to be signed and sealed by a licensed engineer.

Moved by Board Member Rockwell, supported by Board Member Kreutzberg, to deny Case #24-21 for Christopher Malysz of 1330 Clark Lake Road appealing the decision regarding interpretation of conditions for approval of Zoning Board of Appeals Case 14-21. **The motion carried unanimously**

4. 24-22...A request by Doug and Jenifer Kern, 977 Sunrise Park, for front yard setback variance and any other variances deemed necessary by the Zoning Board of Appeals, to construct a new home.

Mr. and Mrs. Doug and Jennifer Kern were present. Ms. Kern stated that they are requesting a front yard variance to make their summer cottage a year-round home. The front of the new home will be in the same location as the current home. They will be widening it two feet, adding two feet towards the lake, and demolishing and rebuilding the garage. They are within the setbacks for the water's edge and the side-yard setbacks. They are keeping the same sight lines as their neighbors.

Ms. Ruthig stated that the applicant has worked with staff to ensure they are requesting the least amount necessary.

Board Member Rockwell asked for clarification on the amount of the variance needed based on the topographical map in the packet. Ms. Ruthig confirmed that the amount of the setback will be 14 feet. He advised the applicant that the deck cannot be covered.

The call to the public was made at 7:10 pm with no response.

Moved by Board Member Rockwell, supported by Board Member Kreutzberg, to approve Case #24-22 for Doug and Jenifer Kern of 977 Sunrise Park, for a front yard setback variance of 21 feet from the required 35 feet for a front yard setback of 14 feet, to construct a new single-family home, based on the following findings of fact:

Strict compliance with the front yard setback would prevent the applicant from constructing
the new home. There are other homes in the vicinity that have reduced front yard setbacks.
 Granting of this variance would do substantial justice to the applicant and is necessary for

the preservation and enjoyment of a substantial property right similar to that possessed by other properties in the same zoning district and in the vicinity of the subject parcel.

- The exceptional or extraordinary condition of the property is the topography of the lot and the narrow building envelope. The variance request appears to be the least amount necessary and provides for adequate parking on the lot. The variance request is not selfcreated.
- The granting of this variance will not impair an adequate supply of light and air to adjacent property or unreasonably increase the congestion in public streets or increase the danger of fire or endanger the public safety, comfort, morals or welfare of the inhabitants of the Township of Genoa.
- The proposed variance would have little or no impact on the appropriate development, continued use, or value of adjacent properties and the surrounding neighborhood.

This approval is conditioned upon the following:

- 1. The structure must be guttered with downspouts.
- 2. Any retaining walls must comply with Article 11.04.03 (J) Retaining Walls section of the Zoning Ordinance.
- 3. The building height cannot exceed 25 feet.
- 4. The detached garage shall be removed.

The motion carried unanimously

5. 24-23...A request by Keepin It Realz LLC, 3220 E. Grand River, for a variance to split property and any other variances deemed necessary by the Zoning Board of Appeals.

Mr. Adam Fasick, Mr. Saman Abro, and Mr. Zaid Abro were present. Mr. Fasick stated they are requesting a variance to parcel out a part of his property at 3220 East Grand River to the adjacent one at 3200 E Grand River. This will allow the property owner of 3200 to expand their car wash. Currently both of these properties are non-conforming. This transfer will allow one to conform to the ordinance and one to become less conforming than it is now.

Chairperson McCreary is concerned that one parcel will be less than one acre, without the required minimum width, which will make the need for any variances self-created and could affect the approval of variances in the future. Mr. Fasick noted that his property is already non-conforming. He does not have any plans to expand his business or increase the size of his building.

The call to the public was made at 8:19 pm with no response.

Moved by Board Member Kreutzberg, supported by Board Member Fons, to approve Case #24-23 for Adam Fasick of Keepin It Realz, LLC of 3220 E. Grand River for two dimensional variances to permit a land division/combination to reduce the conforming lot width of 3200 E. Grand River from 159.59 feet to 137.59 feet where a minimum of 150 feet is required and to permit a land division/combination to reduce the already nonconforming lot area of 3220 E.

Grand River from 0.97 acres to 0.83 acres where a minimum of one acre is required, based on the following findings of fact:

- This variance will provide substantial justice as it is not self-created, is the least necessary and would make the property consistent with other properties in the GCD zoning area, as there appears to be multiple developed properties along this portion of Grand River that fail to meet at least one of the GCD dimensional requirements.
- The variance is necessary due to extraordinary circumstances, such as both properties are currently deficient in minimum GCD dimensional standards. Strict compliance with the minimum GCD dimensional standards cannot be achieved for both properties, yet the request will eliminate non-conforming conditions on both properties, such as non-conforming property size and a nonconforming building.
- Granting this variance would not impair adequate light or air to adjacent properties, would not increase congestion or increase danger or fire or threaten public safety or welfare.
- The variance would have little or no impact on the appropriate development, continued use or value of adjacent properties and surrounding neighborhood.

This approval is conditioned upon the following:

- The nonconforming accessory building shall be removed
- The application form shall be corrected to stated 22 feet of width and not 40 feet.
- Any future development on either property shall obtain necessary zoning approvals, including but not limited to, special land use and site plan review.

The motion carried unanimously

Administrative Business:

1. Approval of minutes for the June 18, 2024 Zoning Board of Appeals meeting.

Moved by Board Member Kreutzberg, supported by Board Member Fons, to approve the minutes of the June 18, 2024 Zoning Board of Appeals meeting as presented. **The motion carried unanimously.**

2. Correspondence

Ms. Ruthig stated there will be two cases on the August agenda.

3. Member Discussion

There were no items to discuss this evening.

4. Adjournment

Moved by Board Member Fons, supported by Board Member Rockwell, to adjourn the meeting at 8:34 pm. **The motion carried unanimously**.

Respectfully submitted:

Patty Thomas, Recording Secretary

